## HISTORIC AND DESIGN REVIEW COMMISSION

November 17, 2021

**HDRC CASE NO:** 2021-570

**ADDRESS:** 555 S ALAMO ST

**LEGAL DESCRIPTION:** NCB 901 BLK LOT 44, 45 & 46

**ZONING:** D, H, RIO-3

CITY COUNCIL DIST.: 1

**DISTRICT:** La Villita Historic District LANDMARK: Individual Landmark

**APPLICANT:** James McKnight/Brown & Ortiz, PC **OWNER:** Eric Stone/SAUTO HOTEL LLC

**TYPE OF WORK:** New construction **APPLICATION RECEIVED:** October 28, 2021

**60-DAY REVIEW:** Not applicable due to City Council Emergency Orders

**CASE MANAGER:** Edward Hall

**REQUEST:** 

The applicant is requesting a Certificate of Appropriateness for approval to:

- 1. Perform exterior modifications to the existing hotel structure to include painting, balcony refinishing, roof replacement, exterior finish repair and balcony door replacement.
- 2. Perform modifications to the pool area to include landscaping, hardscaping and the construction of pool cabanas.
- 3. Perform rehabilitative scopes of work to all three historic structures (Arciniega, Tyler, Staffel) to include painting and façade repairs.
- 4. Perform modifications to the historic Arciniega House including the installation of two window openings on the north façade.
- 5. Construct an event center to be located at the immediate rear of the existing hotel structure.
- 6. Construct a fitness center structure to be located at the southwest corner of the site, to the immediate south of the Staffel House
- 7. Install new signage throughout the site to include new monument signs and new building signage. The existing signage totals five signs for a total of 326 square feet. The proposed signage will total six signs for a total of 726 square feet.

## **APPLICABLE CITATIONS:**

Historic Design Guidelines, Chapter 2, Guidelines for Exterior Maintenance and Alterations

6. Architectural Features: Doors, Windows, and Screens

## A. MAINTENANCE (PRESERVATION)

- *i. Openings*—Preserve existing window and door openings. Avoid enlarging or diminishing to fit stock sizes or air conditioning units. Avoid filling in historic door or window openings. Avoid creating new primary entrances or window openings on the primary façade or where visible from the public right of-way.
- ii. Doors—Preserve historic doors including hardware, fanlights, sidelights, pilasters, and entablatures.
- *iii.* Windows—Preserve historic windows. When glass is broken, the color and clarity of replacement glass should match the original historic glass.

## B. ALTERATIONS (REHABILITATION, RESTORATION, AND RECONSTRUCTION)

- *i. Doors*—Replace doors, hardware, fanlight, sidelights, pilasters, and entablatures in-kind when possible and when deteriorated beyond repair. When in-kind replacement is not feasible, ensure features match the size, material, and profile of the historic element.
- *ii. New entrances*—Ensure that new entrances, when necessary to comply with other regulations, are compatible in size, scale, shape, proportion, material, and massing with historic entrances.
- iii. Glazed area—Avoid installing interior floors or suspended ceilings that block the glazed area of historic windows.

- *iv. Window design*—Install new windows to match the historic or existing windows in terms of size, type, configuration, material, form, appearance, and detail when original windows are deteriorated beyond repair.
- v. *Muntins*—Use the exterior muntin pattern, profile, and size appropriate for the historic building when replacement windows are necessary. Do not use internal muntins sandwiched between layers of glass.

Historic Design Guidelines, Chapter 4, Guidelines for New Construction

## 1. Building and Entrance Orientation

## A. FAÇADE ORIENTATION

i. Setbacks—Align front facades of new buildings with front facades of adjacent buildings where a consistent setback has been established along the street frontage. Use the median setback of buildings along the street frontage where a variety of setbacks exist. Refer to UDC Article 3, Division 2. Base Zoning Districts for applicable setback requirements. ii. Orientation—Orient the front façade of new buildings to be consistent with the predominant orientation of historic buildings along the street frontage.

## **B. ENTRANCES**

- *i. Orientation*—Orient primary building entrances, porches, and landings to be consistent with those historically found along the street frontage. Typically, historic building entrances are oriented towards the primary street.
- 2. Building Massing and Form

## A. SCALE AND MASS

- *i. Similar height and scale*—Design new construction so that its height and overall scale are consistent with nearby historic buildings. In residential districts, the height and scale of new construction should not exceed that of the majority of historic buildings by more than one-story. In commercial districts, building height shall conform to the established pattern. If there is no more than a 50% variation in the scale of buildings on the adjacent block faces, then the height of the new building shall not exceed the tallest building on the adjacent block face by more than 10%.
- *ii. Transitions*—Utilize step-downs in building height, wall-plane offsets, and other variations in building massing to provide a visual transition when the height of new construction exceeds that of adjacent historic buildings by more than one-half story.
- *iii. Foundation and floor heights*—Align foundation and floor-to-floor heights (including porches and balconies) within one foot of floor-to-floor heights on adjacent historic structures.

## B. ROOF FORM

- *i. Similar roof forms*—Incorporate roof forms—pitch, overhangs, and orientation—that are consistent with those predominantly found on the block. Roof forms on residential building types are typically sloped, while roof forms on nonresidential building types are more typically flat and screened by an ornamental parapet wall.
- *ii. Façade configuration*—The primary façade of new commercial buildings should be in keeping with established patterns. Maintaining horizontal elements within adjacent cap, middle, and base precedents will establish a consistent street wall through the alignment of horizontal parts. Avoid blank walls, particularly on elevations visible from the street. No new façade should exceed 40 linear feet without being penetrated by windows, entryways, or other defined bays.

## D. LOT COVERAGE

- *i. Building to lot ratio*—New construction should be consistent with adjacent historic buildings in terms of the building to lot ratio. Limit the building footprint for new construction to no more than 50 percent of the total lot area, unless adjacent historic buildings establish a precedent with a greater building to lot ratio.
- 3. Materials and Textures

## A. NEW MATERIALS

*i. Complementary materials*—Use materials that complement the type, color, and texture of materials traditionally found in the district. Materials should not be so dissimilar as to distract from the historic interpretation of the district. For example, corrugated metal siding would not be appropriate for a new structure in a district comprised of homes with wood siding.

- ii. Alternative use of traditional materials—Consider using traditional materials, such as wood siding, in a new way to provide visual interest in new construction while still ensuring compatibility.
- iii. Roof materials—Select roof materials that are similar in terms of form, color, and texture to traditionally used in the
- iv. Metal roofs—Construct new metal roofs in a similar fashion as historic metal roofs. Refer to the Guidelines for Alterations and Maintenance section for additional specifications regarding metal roofs.
- v. Imitation or synthetic materials—Do not use vinyl siding, plastic, or corrugated metal sheeting. Contemporary materials not traditionally used in the district, such as brick or simulated stone veneer and Hardie Board or other fiberboard siding, may be appropriate for new construction in some locations as long as new materials are visually similar to the traditional material in dimension, finish, and texture. EIFS is not recommended as a substitute for actual stucco.

## 4. Architectural Details

### A. GENERAL

- i. Historic context—Design new buildings to reflect their time while respecting the historic context. While new construction should not attempt to mirror or replicate historic features, new structures should not be so dissimilar as to distract from or diminish the historic interpretation of the district.
- ii. Architectural details—Incorporate architectural details that are in keeping with the predominant architectural style along the block face or within the district when one exists. Details should be simple in design and should complement, but not visually compete with, the character of the adjacent historic structures or other historic structures within the

Architectural details that are more ornate or elaborate than those found within the district are inappropriate.

iii. Contemporary interpretations—Consider integrating contemporary interpretations of traditional designs and details for new construction. Use of contemporary window moldings and door surroundings, for example, can provide visual interest while helping to convey the fact that the structure is new. Modern materials should be implemented in a way that does not distract from the historic structure.

## 5. Garages and Outbuildings

### A. DESIGN AND CHARACTER

- i. Massing and form—Design new garages and outbuildings to be visually subordinate to the principal historic structure in terms of their height, massing, and form.
- ii. Building size New outbuildings should be no larger in plan than 40 percent of the principal historic structure
- iii. Character—Relate new garages and outbuildings to the period of construction of the principal building on the lot through the use of complementary materials and simplified architectural details.
- iv. Windows and doors—Design window and door openings to be similar to those found on historic garages or outbuildings in the district or on the principle historic structure in terms of their spacing and proportions.
- v. Garage doors—Incorporate garage doors with similar proportions and materials as those traditionally found in the district.

## **B. SETBACKS AND ORIENTATION**

- i. Orientation—Match the predominant garage orientation found along the block. Do not introduce front-loaded garages or garages attached to the primary structure on blocks where rear or alley loaded garages were historically used.
- ii. Setbacks—Follow historic setback pattern of similar structures along the streetscape or district for new garages and outbuildings. Historic garages and outbuildings are most typically located at the rear of the lot, behind the principal building. In some instances, historic setbacks are not consistent with UDC requirements and a variance may be required.
- 6. Mechanical Equipment and Roof Appurtenances

## A. LOCATION AND SITING

- i. Visibility—Do not locate utility boxes, air conditioners, rooftop mechanical equipment, skylights, satellite dishes, and other roof appurtenances on primary facades, front-facing roof slopes, in front yards, or in other locations that are clearly visible from the public right-of-way.
- ii. Service Areas—Locate service areas towards the rear of the site to minimize visibility from the public right-of-way.

## **B. SCREENING**

- *i. Building-mounted equipment*—Paint devices mounted on secondary facades and other exposed hardware, frames, and piping to match the color scheme of the primary structure or screen them with landscaping.
- *ii. Freestanding equipment*—Screen service areas, air conditioning units, and other mechanical equipment from public view using a fence, hedge, or other enclosure.
- *iii. Roof-mounted equipment*—Screen and set back devices mounted on the roof to avoid view from public right-of-way. Historic Design Guidelines, Chapter 5, Guidelines for Site Elements

Historic Design Guidelines, Chapter 5, Guidelines for Site Elements

## **B. NEW FENCES AND WALLS**

- *i. Design*—New fences and walls should appear similar to those used historically within the district in terms of their scale, transparency, and character. Design of fence should respond to the design and materials of the house or main structure.
- *ii.* Location—Avoid installing a fence or wall in a location where one did not historically exist, particularly within the front yard. The appropriateness of a front yard fence or wall is dependent on conditions within a specific historic district.

New front yard fences or wall should not be introduced within historic districts that have not historically had them. iii. Height—Limit the height of new fences and walls within the front yard to a maximum of four feet. The appropriateness of a front yard fence is dependent on conditions within a specific historic district. New front yard fences should not be introduced within historic districts that have not historically had them. If a taller fence or wall existed historically, additional height may be considered. The height of a new retaining wall should not exceed the height of the slope it retains.

*iv. Prohibited materials*—Do not use exposed concrete masonry units (CMU), Keystone or similar interlocking retaining

wall systems, concrete block, vinyl fencing, or chain link fencing.

v. Appropriate materials—Construct new fences or walls of materials similar to fence materials historically used in the district. Select materials that are similar in scale, texture, color, and form as those historically used in the district, and that are compatible with the main structure. Screening incompatible uses—Review alternative fence heights and materials for appropriateness where residential properties are adjacent to commercial or other potentially incompatible uses.

## 3. Landscape Design

## A. PLANTINGS

- i. Historic Gardens— Maintain front yard gardens when appropriate within a specific historic district.
- ii. Historic Lawns—Do not fully remove and replace traditional lawn areas with impervious hardscape. Limit the removal of lawn areas to mulched planting beds or pervious hardscapes in locations where they would historically be found, such as along fences, walkways, or drives. Low-growing plantings should be used in historic lawn areas; invasive or large-scale species should be avoided. Historic lawn areas should never be reduced by more than 50%. *iii. Native xeric plant materials*—Select native and/or xeric plants that thrive in local conditions and reduce watering usage. See UDC Appendix E: San Antonio Recommended Plant List—All Suited to Xeriscape Planting Methods, for a list of appropriate materials and planting methods. Select plant materials with a similar character, growth habit, and light requirements as those being replaced.
- *iv. Plant palettes*—If a varied plant palette is used, incorporate species of taller heights, such informal elements should be restrained to small areas of the front yard or to the rear or side yard so as not to obstruct views of or otherwise distract

from the historic structure.

v. *Maintenance*—Maintain existing landscape features. Do not introduce landscape elements that will obscure the historic structure or are located as to retain moisture on walls or foundations (e.g., dense foundation plantings or vines) or as to cause damage.

## B. ROCKS OR HARDSCAPE

- *i. Impervious surfaces* —Do not introduce large pavers, asphalt, or other impervious surfaces where they were not historically located.
- ii. Pervious and semi-pervious surfaces—New pervious hardscapes should be limited to areas that are not highly visible,

and should not be used as wholesale replacement for plantings. If used, small plantings should be incorporated into the design.

*iii.* Rock mulch and gravel - Do not use rock mulch or gravel as a wholesale replacement for lawn area. If used, plantings should be incorporated into the design.

### D. TREES

- *i. Preservation*—Preserve and protect from damage existing mature trees and heritage trees. See UDC Section 35-523 (Tree Preservation) for specific requirements.
- *ii.* New Trees Select new trees based on site conditions. Avoid planting new trees in locations that could potentially cause damage to a historic structure or other historic elements. Species selection and planting procedure should be done in accordance with guidance from the City Arborist.
- 5. Sidewalks, Walkways, Driveways, and Curbing

## A. SIDEWALKS AND WALKWAYS

- *i. Maintenance*—Repair minor cracking, settling, or jamming along sidewalks to prevent uneven surfaces. Retain and repair historic sidewalk and walkway paving materials—often brick or concrete—in place.
- *ii. Replacement materials*—Replace those portions of sidewalks or walkways that are deteriorated beyond repair. Every effort should be made to match existing sidewalk color and material.
- *iii.* Width and alignment—Follow the historic alignment, configuration, and width of sidewalks and walkways. Alter the historic width or alignment only where absolutely necessary to accommodate the preservation of a significant tree.
- *iv. Stamped concrete*—Preserve stamped street names, business insignias, or other historic elements of sidewalks and walkways when replacement is necessary.
- v. ADA compliance—Limit removal of historic sidewalk materials to the immediate intersection when ramps are added to address ADA requirements.

### **B. DRIVEWAYS**

- *i. Driveway configuration*—Retain and repair in place historic driveway configurations, such as ribbon drives. Incorporate a similar driveway configuration—materials, width, and design—to that historically found on the site. Historic driveways are typically no wider than 10 feet. Pervious paving surfaces may be considered where replacement is necessary to increase stormwater infiltration.
- *ii. Curb cuts and ramps*—Maintain the width and configuration of original curb cuts when replacing historic driveways. Avoid introducing new curb cuts where not historically found.

## 7. Off-Street Parking

## A. LOCATION

- i. Preferred location—Place parking areas for non-residential and mixed-use structures at the rear of the site, behind primary structures to hide them from the public right-of-way. On corner lots, place parking areas behind the primary structure and set them back as far as possible from the side streets. Parking areas to the side of the primary structure are acceptable when location behind the structure is not feasible. See UDC Section 35-310 for district-specific standards. ii. Front—Do not add off-street parking areas within the front yard setback as to not disrupt the continuity of the streetscape.
- *iii.* Access—Design off-street parking areas to be accessed from alleys or secondary streets rather than from principal streets whenever possible.

### B. DESIGN

- *i. Screening*—Screen off-street parking areas with a landscape buffer, wall, or ornamental fence two to four feet high—or a combination of these methods. Landscape buffers are preferred due to their ability to absorb carbon dioxide. See UDC Section 35-510 for buffer requirements.
- *ii. Materials*—Use permeable parking surfaces when possible to reduce run-off and flooding. See UDC Section 35-526(j) for specific standards.
- iii. Parking structures—Design new parking structures to be similar in scale, materials, and rhythm of the surrounding

historic district when new parking structures are necessary.

Standard Specifications for Windows in Additions and New Construction

Consistent with the Historic Design Guidelines, the following recommendations are made for windows to be used in new construction:

- GENERAL: Windows used in new construction should be similar in appearance to those commonly found
  within the district in terms of size, profile, and configuration. While no material is expressly prohibited by the
  Historic Design Guidelines, a high quality wood or aluminum-clad wood window product often meets the
  Guidelines with the stipulations listed below.
- SIZE: Windows should feature traditional dimensions and proportions as found within the district.
- SASH: Meeting rails must be no taller than 1.25". Stiles must be no wider than 2.25". Top and bottom sashes must be equal in size unless otherwise approved.
- DEPTH: There should be a minimum of 2" in depth between the front face of the window trim and the front face of the top window sash. This must be accomplished by recessing the window sufficiently within the opening or with the installation of additional window trim to add thickness. All windows should be supplied in a block frame and exclude nailing fins which limit the ability to sufficiently recess the windows.
- TRIM: Window trim must feature traditional dimensions and architecturally appropriate casing and sloped sill detail.
- GLAZING: Windows should feature clear glass. Low-e or reflective coatings are not recommended for replacements. The glazing should not feature faux divided lights with an interior grille. If approved to match a historic window configuration, the window should feature true, exterior muntins.
- COLOR: Wood windows should feature a painted finish. If a clad or non-wood product is approved, white or metallic manufacturer's color is not allowed and color selection must be presented to staff.

## **FINDINGS:**

- a. The applicant is requesting a Certificate of Appropriateness for approval to perform various modifications, rehabilitative scopes of work and new construction at 555 S Alamo. This property is located within the La Villita Historic District and the River Improvement Overlay, District 3.
- b. DESIGN REVIEW COMMITTEE This request was reviewed by the Design Review Committee on
- c. EXISTING SITE The property bounded by S Alamo, Cesar E Chavez, S Presa and Arciniega Streets features a multi-story hotel tower, three historic structures, the Arciniega, Tyler and Staffel Houses and various site elements.
- d. EXISTING HOTEL STRUCTURE The applicant has proposed to perform exterior modifications to the existing hotel structure to include painting, balcony refinishing, roof replacement, exterior finish repair and balcony door replacement. Generally, staff finds the proposed improvements to be appropriate and consistent with the Historic Design Guidelines and Unified Development Code.
- e. POOL AREA MODIFICATIONS The applicant has proposed to perform modifications to the pool area to include landscaping, hardscaping and the construction of pool cabanas. Generally, staff finds the proposed modifications to be appropriate. Final construction documents for the landscaping, hardscaping and pool cabanas should be submitted to OHP staff for review and approval.
- f. REHABILITATION The applicant has proposed modifications to the three historic structures on site, the Arciniega, Tyler and Staffel houses to include painting and façade repair. Generally, staff finds the proposed rehabilitative scopes of work to be appropriate. All elements that are beyond deterioration should be replaced, in-kind. Brick and stone that is currently unpainted should remain unpainted.
- g. ARCINIEGA HOUSE The applicant has proposed exterior modifications to the Arciniega House to include the installation of two window openings on the south façade. The south façade is currently void of window openings. Generally, staff finds the proposed modifications to be appropriate given that the modifications are proposed on the rear façade. The applicant has proposed for both the openings and windows to match the existing in dimension and materiality. Staff finds this to be appropriate.
- h. EVENT CENTER The applicant has proposed to construct an event center to be located at the immediate rear of the existing hotel structure. The proposed structure will feature a footprint of approximately 3,240 square feet and an overall height of approximately twenty-four (24) feet. Generally, staff finds the location, footprint and massing of the proposed event center to be appropriate and consistent with the Guidelines for New Construction.

- i. EVENT CENTER (Materials) The applicant has proposed materials that include a standing seam metal roof, composite wood panels feature a faux wood grain and horizontal profile and metal windows and doors. Staff finds that the proposed siding should feature a smooth finish instead of the proposed faux wood finish. Additionally, staff finds that the proposed standing seam metal roof should feature panels that are 18 to 21 inches wide, seams that are 1to 2 inches in height and a crimped ridge seam. A low profile ridge cap may be submitted for review and approval by the Commission for new construction. Generally, staff finds the proposed zinc finish for the metal roof to be appropriate as it is comparable in color to the standard galvalume finish.
- j. WINDOWS The applicant has proposed to install metal windows. Generally, staff finds the installation of metal windows to be appropriate; however, staff finds that all windows should be recessed at least two (2) inches within walls. All window frames, including frames of storefront systems should feature a dark finish.
- k. ARCHITECTURAL DETAILS Generally, staff finds the architectural details of the proposed event center to be appropriate. Staff finds that the proposed composite siding should feature a smooth finish, as noted in finding i.
- 1. FINTESS CENTER The applicant has proposed to construct a fitness center to be located to the south of the Staffel House. The proposed structure will feature a footprint of approximately 1,500 square feet. Generally, staff finds the location, footprint and massing of the proposed fitness center to be appropriate.
- m. FITNESS CENTER (Setback) The applicant has noted a setback from S Presa that is comparable to the setback of the Staffel House. Staff finds an equal or greater setback than that of the Staffel House to be appropriate.
- n. FITNESS CENTER (Materials) The applicant has proposed materials for the fitness center that include standing seam metal roof, composite wood panels feature a faux wood grain and horizontal profile and metal windows and doors. Staff finds that the proposed siding should feature a smooth finish instead of the proposed faux wood finish. Additionally, staff finds that the proposed standing seam metal roof should feature panels that are 18 to 21 inches wide, seams that are 1to 2 inches in height and a crimped ridge seam. A low profile ridge cap may be submitted for review and approval by the Commission for new construction. Generally, staff finds the proposed zinc finish for the metal roof to be appropriate as it is comparable in color to the standard galvalume finish.
- o. WINDOWS The applicant has proposed to install metal windows. Generally, staff finds the installation of metal windows to be appropriate; however, staff finds that all windows should be recessed at least two (2) inches within walls. All window frames, including frames of storefront systems should feature a dark finish.
- p. ARCHITECTURAL DETAILS Generally, staff finds the architectural details of the proposed event center to be appropriate. Staff finds that the proposed composite siding should feature a smooth finish, as noted in finding n.
- q. SIGNAGE The applicant has proposed to install new signage throughout the site to include new monument signs and new building signage. The existing signage totals five signs for a total of 326 square feet. The proposed signage will total six signs for a total of 726 square feet.
- r. ALLOWABLE SIGNAGE The Historic Design Guidelines recommend one major and two minor signs per application, not to exceed fifty (50) square feet total. The Commission may approve additional signage and square footage.
- s. MONUMENT SIGNS The applicant has proposed to install three monument signs. One sign will be located at the intersection of S Alamo and Arciniega, one will be located at Arciniega and S Presa, and one will be located at within an existing landscaped are on Arciniega. The applicant has proposed for each sign to feature fifty (50) square feet, per side, to include a total of one hundred (100) square feet. The proposed signs will feature indirect illumination. While the size of the proposed signs exceeds the size recommended by the Guidelines for Signage, staff finds that given the size of the lot, the proposed size and number of signs are appropriate; however, staff finds that the proposed signage should not exceed six (6) feet in height, per the Guidelines.
- t. BUILDING SIGNS The applicant has proposed to install two new building signs, one to be located on the east facing façade near Cesar E Chavez and one to be located on the south facing façade near S Alamo. The applicant has proposed for both signs to feature 150 square feet and halo lighting. Generally, staff finds the proposed signage to be appropriate.
- u. BUILDING SIGN (Repair) The applicant has noted that the existing building sign on the north facing façade near S Alamo will be repaired. Staff finds this to be appropriate; however, the proposed signage repair should remain consistent with the Guidelines.


## **RECOMMENDATION:**

- 1. Staff recommends approval of item #1, rehabilitation to the existing hotel structure, as submitted, based on finding d.
- 2. Staff recommends approval of item #2, modifications to the pool area to include landscaping, hardscaping and the construction of pool cabanas, based on finding e with the stipulation that final construction documents for the landscaping, hardscaping and pool cabanas should be submitted to OHP staff for review and approval.
- 3. Staff recommends approval of item #3, rehabilitative scopes of work to all three historic structures (Arciniega, Tyler, Staffel) to include painting and façade repairs with the following stipulations:
  - i. That all elements that are beyond repair should be replaced, in-kind.
  - ii. That brick and stone that is currently unpainted should remain unpainted.
- 4. Staff recommends approval of item #4, modifications to the rear of the Arciniega House based on finding g, as submitted.
- 5. Staff recommends approval of item #5, the construction of an event center, based on findings h through k with the following stipulations:
  - i. That the proposed standing seam metal roof should feature panels that are 18 to 21 inches wide, seams that are 1 to 2 inches in height and a crimped ridge seam. A low profile ridge cap may be submitted for review and approval by the Commission for new construction.
  - ii. That all composite siding should feature a smooth finish.
  - iii. That the proposed metal windows are inset two (2) inches within walls, feature dark colored frames and that all storefront systems feature dark colored frames.
- 6. Staff recommends approval of item #6, the construction of a fitness center based on findings l through p with the following stipulations:
  - i. That the new construction maintain a setback that is equal to or greater than that of the adjacent Staffel House.
  - ii. That the proposed standing seam metal roof should feature panels that are 18 to 21 inches wide, seams that are 1 to 2 inches in height and a crimped ridge seam. A low profile ridge cap may be submitted for review and approval by the Commission for new construction.
  - iii. That all composite siding should feature a smooth finish.
  - iv. That the proposed metal windows are inset two (2) inches within walls, feature dark colored frames and that all storefront systems feature dark colored frames.
- 7. Staff recommends approval of item #7, signage, based on findings m through q with the following stipulations:
  - i. That the proposed monument signs do not exceed six (6) feet in height.
  - ii. That all signage is externally illuminated, including existing signage that will be repaired.

A foundation inspection is to be scheduled with OHP staff to ensure that foundation setbacks and heights are consistent with the approved design. The inspection is to occur after the installation of form work and prior to the installation of foundation materials.

A standing seam metal roof inspection is to be schedule with OHP staff to ensure that roofing materials are consistent with approved design. An industrial ridge cap is not to be used.

## City of San Antonio One Stop

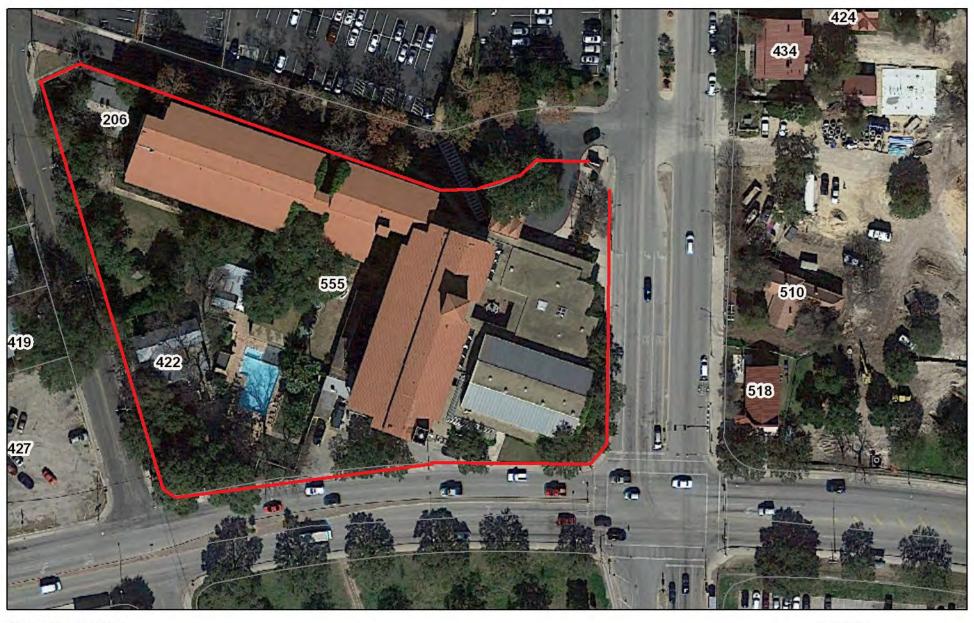

November 12, 2021

CoSA Addresses

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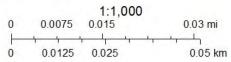
Pre-K Sites

**BCAD Parcels** 

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Community Service Centers

CoSA Parcels





# Historic and Design Review Commission Design Review Committee Report

DATE: October 26, 2021 HDRC Case #: 2021-570

Address: 555 S Alamo Meeting Location: Webex

**APPLICANT: Eric Stone** 

DRC Members present: Jeff Fetzer, Monica Savino

Staff Present: Edward Hall, Hannah Leighner

Others present: Aubrey Hartman (HKS), Terry Dammeyer (White Lodging), James McKnight

REQUEST: Signage, modifications to historic structures, site work, landscaping, repair and maintenance

## **COMMENTS/CONCERNS:**

AH: Overview of updates to existing 1970's hotel structure.

AH: Overview of proposed event building/space.

JF: Comments on fiber cement siding – generally, faux wood grain materials are not recommended.

JF: Questions about materials and profiles for the proposed event center.

AH: Overview of modifications to the Arciniega House.

MS: Questions about the current façade finish – pigmented plaster?

MS: Consider incorporating historic colors into the rehabbed façade.

JF: Questions about the garden façade. The street façade features four windows and two doors (no windows on garden façade). Having a double door on the garden façade may not be appropriate. Would rather see a window pattern similar to street façade. Consider 4 over 4 instead of 6 over 6 to differentiate between the original window openings and new window openings. The double door on the garden façade is a bit over-scaled.

AH: Quick overview of the Tyler House (update and refresh on paint)

AH: Quick overview of the Staffel House – Paint only

AH: Overview of signage

JF: Questions regarding existing monument sign (height)

## **OVERALL COMMENTS:**

## HKS

19 October 2021

San Antonio Hotel Project Scope of Work Current Hotel Name: Marriott Plaza San Antonio

Location: 555 South Alamo Street, San Antonio, Texas 78205

### New Hotel:

### General Overview:

- Complete renovation and conversion of the existing 251 Marriott Plaza San Antonio to Autograph Collection Hotel by Marriott.
- Key count to remain at ~250 keys.
- Majority of MEPF equipment is original. Most, if not all, equipment will need to be replaced
- Exterior skin to be repaired or replaced as required, new finishes to match the character and materiality of La Villita neighborhood


### **Public Spaces**

- Existing Hotel
  - Existing porte cochere finishes and lighting to be upgraded.
     Existing brick vaulting to remain
  - Existing loggia to be converted to interior space, and new hotel entry doors constructed
  - Existing guestroom balconies to be refinished, new doors provided, new integrally lit privacy screens installed, and new railing infill
- Pool upgrade includes
  - o Enhance pool area with landscape and new hardscape
  - o New pool cabanas to be added
  - o Feature Architectural Resort like Pool bar/bistro
- Historic homes
  - All historic structures to be repaired and painted as required.
     Colors and materiality to be consistent within the La Villita neighborhood
  - o Tyler and Staffel [Victoria] Houses to be converted into Hotel Spa
  - o Arciniega House to be converted into hotel Presidential Suite
- New Construction
  - o Addition of new Fitness center along S. Presa Street, in keeping with the residential scale and character of the neighborhood
  - New Event Center to be added onto existing hotel in the current garden. This structure is to match the neighborhood character and materiality

SAN ANTONIO <b>HOTEL</b>
EXTERIOR MATERIALS PALETTE AND UPGRADES

NOVEMBER 2021

## **PROJECT SITE MAP**

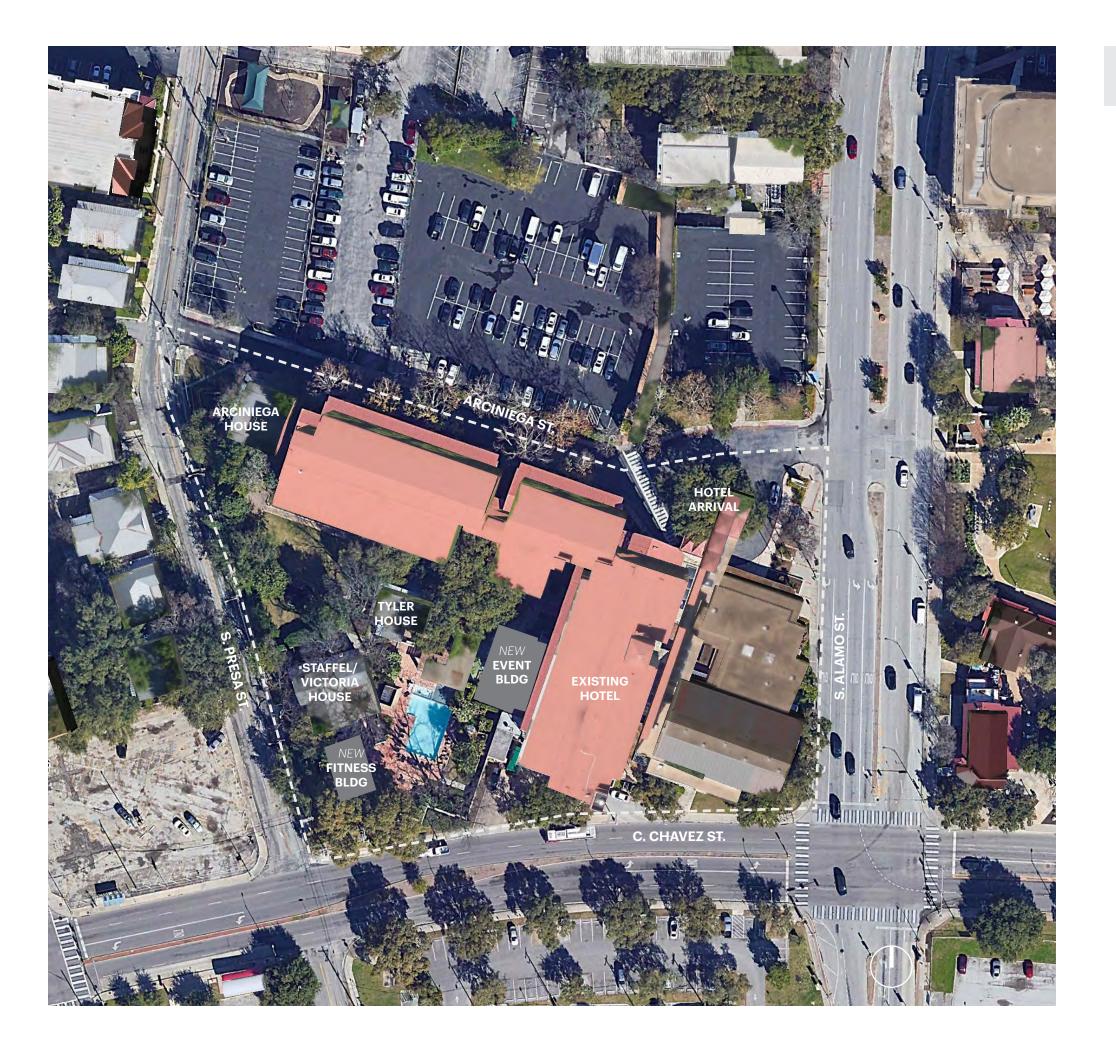









## MAIN HOTEL BUILDING

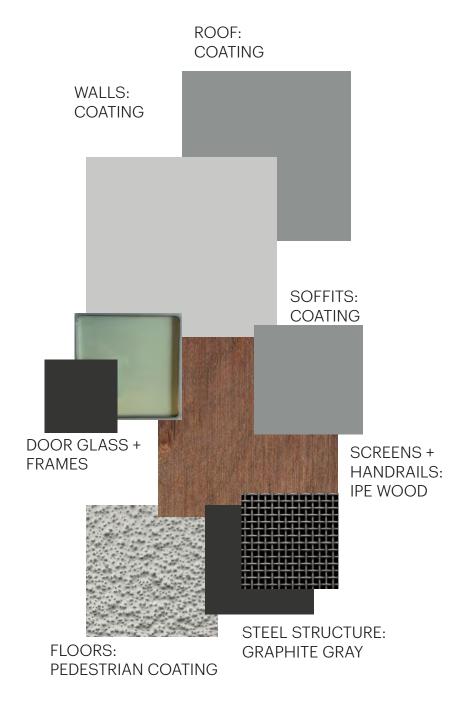

## MAIN HOTEL BUILDING

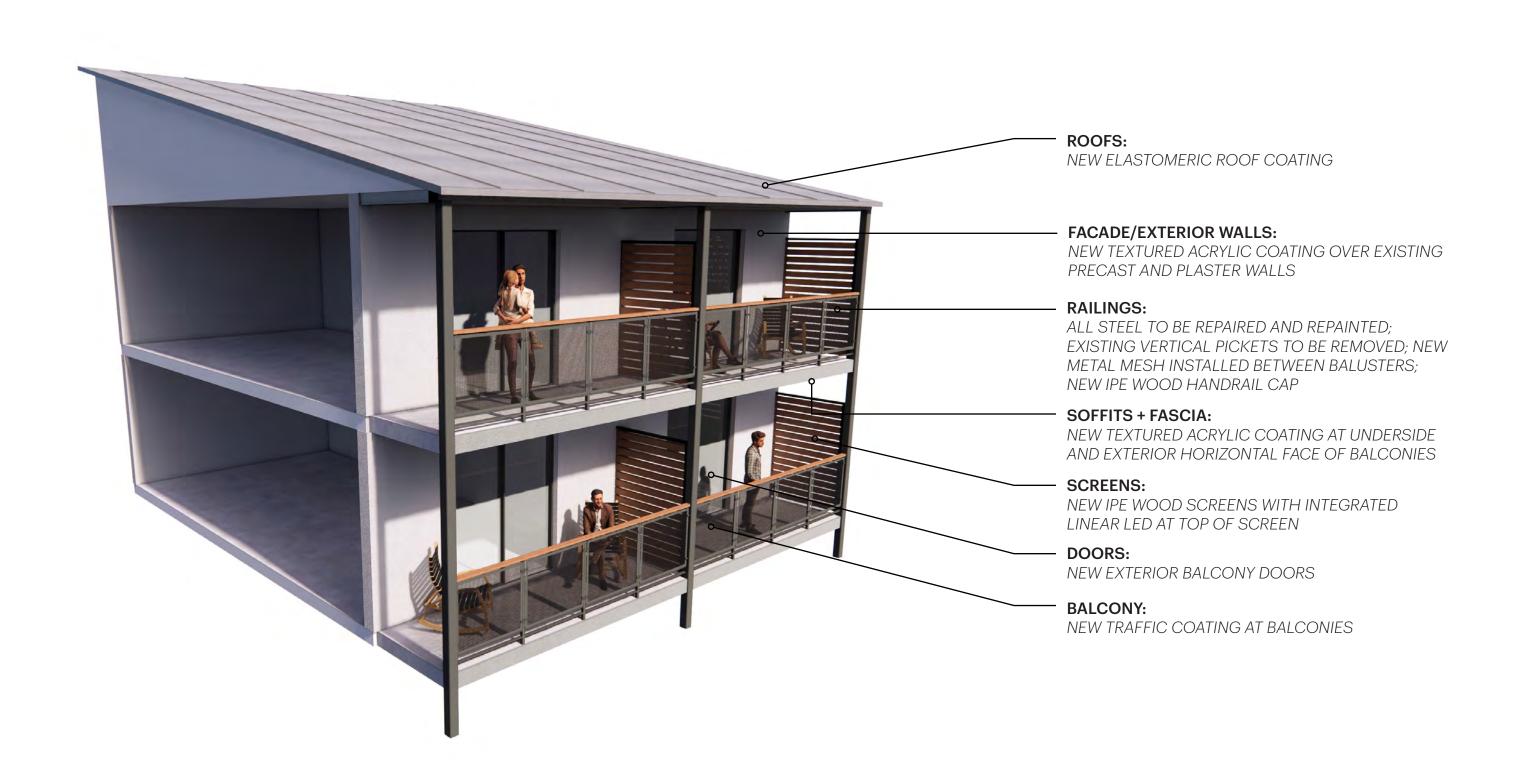






## **NEW EVENT BUILDING**

ROOF AND WALLS: FIELD FABRICATED STANDING SEAM METAL ROOF IN ZINC



FRAMES: DARK GRAY



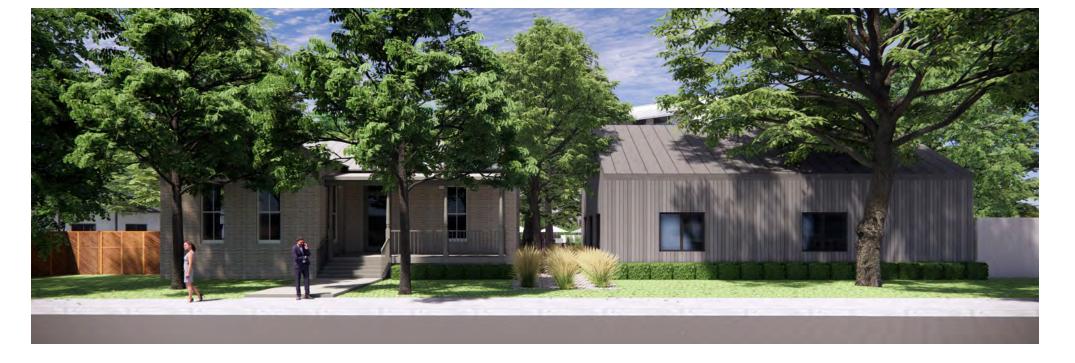

## **NEW FITNESS CENTER BUILDING**

ROOF TYPE 01: FIELD FABRICATED STANDING SEAM METAL ROOF IN ZINC



WINDOWS + DOORS:
PELLA ARCHITECT SERIES
CONTEMPORARY







## **ARCINIEGA HOUSE**


BODY:



TRIM: ACCENT:






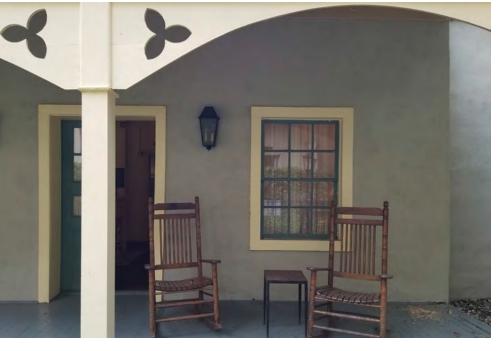

## **TYLER HOUSE**

BODY:

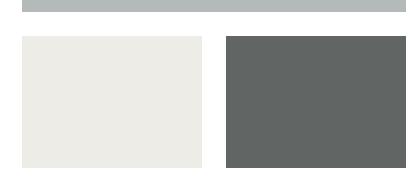


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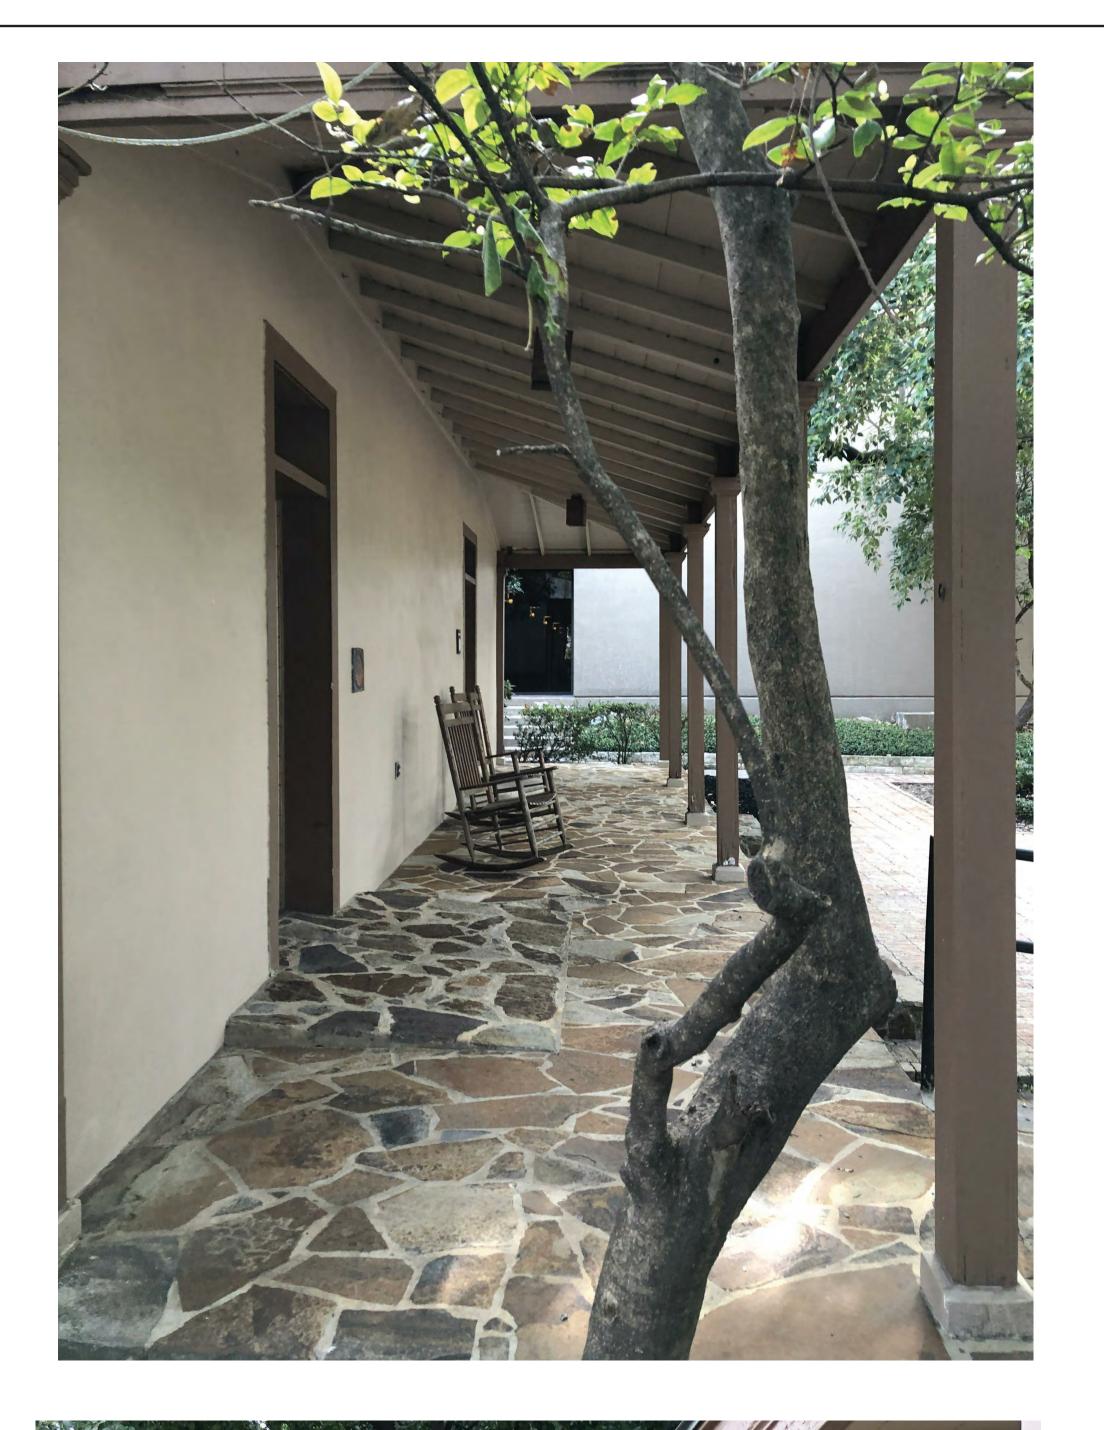


## STAFFEL [VICTORIA] HOUSE

BODY: AT EXISTING PAINTED BRICK ONLY. TO MATCH BRICK COLOR AND TO BE CONFIRMED WITH IN-PLACE COLOR TESTS



TRIM: ACCENT:

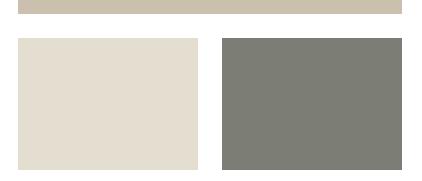









ARCHITECT HKS, INC. 350 N SAINT PAUL ST, SUITE 100 DALLAS, TX 75201

INTERIOR DESIGNER

FLICK-MARS 10440 N. CENTRAL EXPY, NO 1210 DALLAS, TX 75231 STRUCTURAL ENGINEERS THORNTON TOMASETTI 8750 NORTH CENTRAL EXPRESSWAY, SUITE 700 DALLAS, TX 75231

MEPF ENGINEERS BLUM CONSULTING ENGINEERS 8144 WALNUT HILL LANE DALLAS, TX 75231

CIVIL ENGINEER

PAPE-DAWSON ENGINEERS, INC. 2000 NW LOOP 410 SAN ANTONIO, TX 78213 FOOD SERVICE EQUIPMENT NEXT STEP DESIGN 350 S. NORTHWEST HIGHWAY, SUITE 300 PARK RIDGE, IL 60068

LIGHTING CONSULTANT GRANVILLE MCANEAR LIGHTING DESIGN, LLC 3545 AINSWORTH DROVE DALLAS, TX 75229

LANDSCAPE TALLEY ASSOCIATES 1925 SAN JACINTO, SUITE 400 DALLAS, TX 75201

TECHNOLOGY CONSULTANT NETWORK TECHNOLOGY, INC 320 SOUTH PERRY STREET LAWRENCEVILLE, GA 30045 VERTICAL TRANSPORTATION

LERCH BATES 2001 BRYAN STREET, SUITE 1930 DALLAS TX, 75201 LIFE SAFETY ENGINEER

JENSEN HUGHES 2301 W. PLANO PARKWAY, SUITE 210 PLANO, TX 75075

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Arch. Reg. No.: XXXX Date: XX/XX/XXXX

**KEY PLAN** 

REVISION NO. DESCRIPTION

HKS PROJECT NUMBER 23383.000

10/15/21 50% CONSTRCUTION

DOCUMENTS SHEET TITLE ARCINIEGA HOUSE -PHOTOS

SHEET NO.

A10.01









OWNER WHITE LODGING SERVICES CORPORATION 701 EAST 83RD AVE MERRILLVILLE, IN 46410 ARCHITECT

HKS, INC. 350 N SAINT PAUL ST, SUITE 100 DALLAS, TX 75201

INTERIOR DESIGNER FLICK-MARS 10440 N. CENTRAL EXPY, NO 1210 DALLAS, TX 75231

STRUCTURAL ENGINEERS THORNTON TOMASETTI 8750 NORTH CENTRAL EXPRESSWAY, SUITE 700 DALLAS, TX 75231

MEPF ENGINEERS BLUM CONSULTING ENGINEERS 8144 WALNUT HILL LANE DALLAS, TX 75231

CIVIL ENGINEER PAPE-DAWSON ENGINEERS, INC. 2000 NW LOOP 410 SAN ANTONIO, TX 78213

FOOD SERVICE EQUIPMENT NEXT STEP DESIGN 350 S. NORTHWEST HIGHWAY, SUITE 300 PARK RIDGE, IL 60068

LIGHTING CONSULTANT GRANVILLE MCANEAR LIGHTING DESIGN, LLC 3545 AINSWORTH DROVE DALLAS, TX 75229

LANDSCAPE TALLEY ASSOCIATES 1925 SAN JACINTO, SUITE 400 DALLAS, TX 75201

TECHNOLOGY CONSULTANT NETWORK TECHNOLOGY, INC 320 SOUTH PERRY STREET LAWRENCEVILLE, GA 30045

VERTICAL TRANSPORTATION LERCH BATES 2001 BRYAN STREET, SUITE 1930 DALLAS TX, 75201

LIFE SAFETY ENGINEER

JENSEN HUGHES 2301 W. PLANO PARKWAY, SUITE 210 PLANO, TX 75075

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**KEY PLAN** 

Arch. Reg. No.: XXXX Date: XX/XX/XXXX

REVISION

HKS PROJECT NUMBER 23383.000

10/15/21 50% CONSTRCUTION


DOCUMENTS SHEET TITLE ELEMENDORF -TYLER HOUSE -PHOTOS

SHEET NO.

A11.01





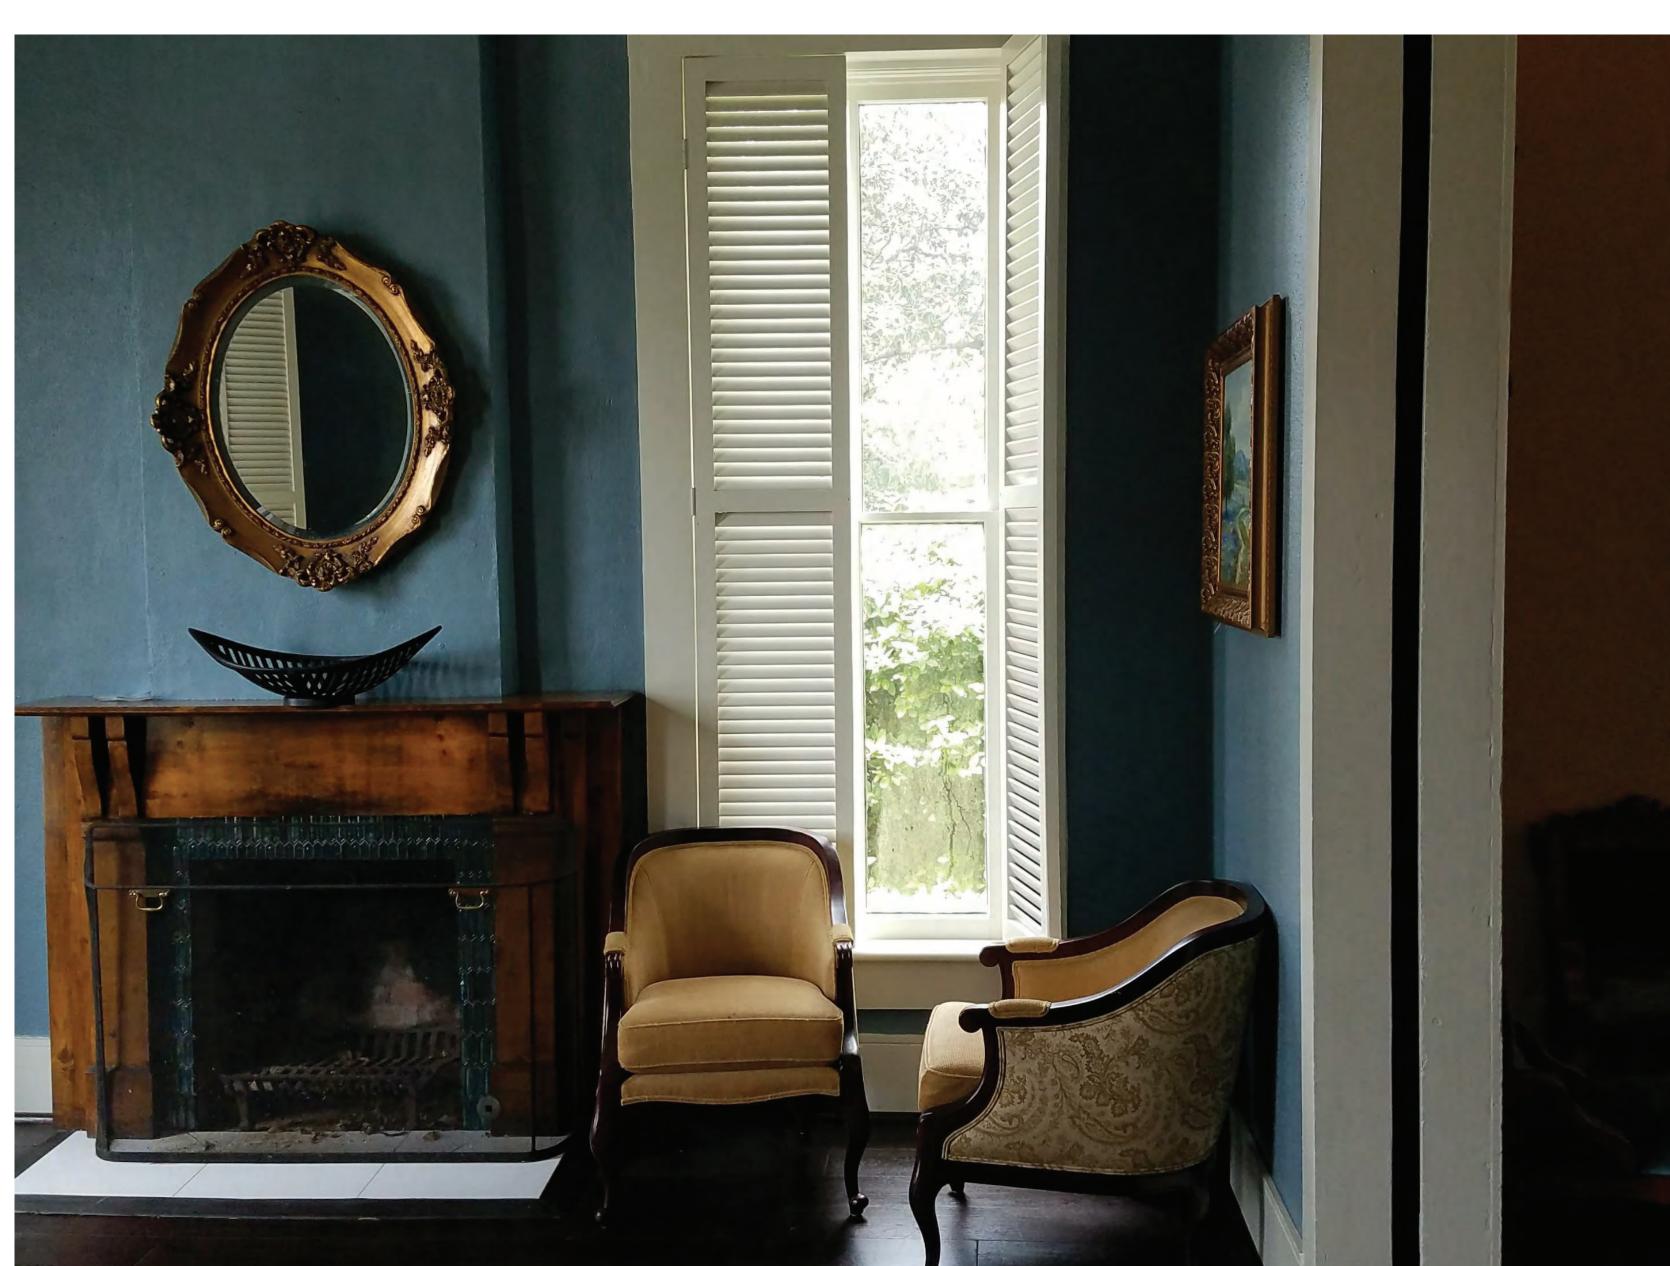



ARCHITECT 350 N SAINT PAUL ST, SUITE 100 DALLAS, TX 75201

INTERIOR DESIGNER FLICK-MARS 10440 N. CENTRAL EXPY, NO 1210 DALLAS, TX 75231

STRUCTURAL ENGINEERS THORNTON TOMASETTI 8750 NORTH CENTRAL EXPRESSWAY, SUITE 700 DALLAS, TX 75231

MEPF ENGINEERS BLUM CONSULTING ENGINEERS 8144 WALNUT HILL LANE DALLAS, TX 75231

CIVIL ENGINEER PAPE-DAWSON ENGINEERS, INC. 2000 NW LOOP 410 SAN ANTONIO, TX 78213

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LIGHTING CONSULTANT GRANVILLE MCANEAR LIGHTING DESIGN, LLC 3545 AINSWORTH DROVE DALLAS, TX 75229

LANDSCAPE TALLEY ASSOCIATES 1925 SAN JACINTO, SUITE 400 DALLAS, TX 75201

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LERCH BATES 2001 BRYAN STREET, SUITE 1930 DALLAS TX, 75201 LIFE SAFETY ENGINEER

JENSEN HUGHES 2301 W. PLANO PARKWAY, SUITE 210 PLANO, TX 75075

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Date: XX/XX/XXXX

**KEY PLAN** 

Arch. Reg. No.: XXXX

HKS PROJECT NUMBER 23383.000 10/15/21

50% CONSTRCUTION DOCUMENTS SHEET TITLE STAFFEL HOUSE -PHOTOS














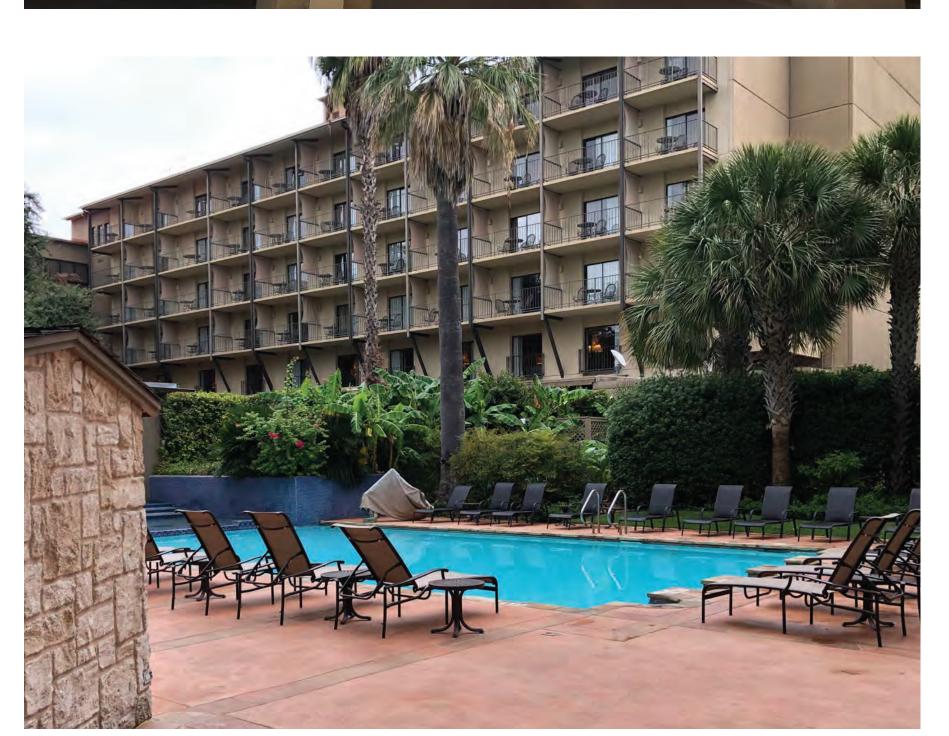



ARCHITECT
HKS, INC.
350 N SAINT PAUL ST, SUITE 100
DALLAS, TX 75201

INTERIOR DESIGNER FLICK-MARS 10440 N. CENTRAL EXPY, NO 1210 DALLAS, TX 75231

STRUCTURAL ENGINEERS THORNTON TOMASETTI 8750 NORTH CENTRAL EXPRESSWAY, SUITE 700 DALLAS, TX 75231

**MEPF ENGINEERS** 

BLUM CONSULTING ENGINEERS 8144 WALNUT HILL LANE DALLAS, TX 75231 **CIVIL ENGINEER** 

PAPE-DAWSON ENGINEERS, INC. 2000 NW LOOP 410 SAN ANTONIO, TX 78213

FOOD SERVICE EQUIPMENT

NEXT STEP DESIGN 350 S. NORTHWEST HIGHWAY, SUITE 300 PARK RIDGE, IL 60068

LIGHTING CONSULTANT GRANVILLE MCANEAR LIGHTING DESIGN, LLC 3545 AINSWORTH DROVE DALLAS, TX 75229

LANDSCAPE
TALLEY ASSOCIATES
1925 SAN JACINTO, SUITE 400
DALLAS, TX 75201

TECHNOLOGY CONSULTANT
NETWORK TECHNOLOGY, INC
320 SOUTH PERRY STREET
LAWRENCEVILLE, GA 30045

**VERTICAL TRANSPORTATION** LERCH BATES 2001 BRYAN STREET, SUITE 1930 DALLAS TX, 75201

LIFE SAFETY ENGINEER

JENSEN HUGHES 2301 W. PLANO PARKWAY, SUITE 210 PLANO, TX 75075

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KEY PLAN

Arch. Reg. No.: XXXX Date: XX/XX/XXXX


HKS PROJECT NUMBER 23383.000

10/15/21 **50% CONSTRCUTION** 

DOCUMENTS
SHEET TITLE
MARRIOTT HOTEL **PHOTOS** 

SHEET NO. A13.01

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**ARCHITECT** 

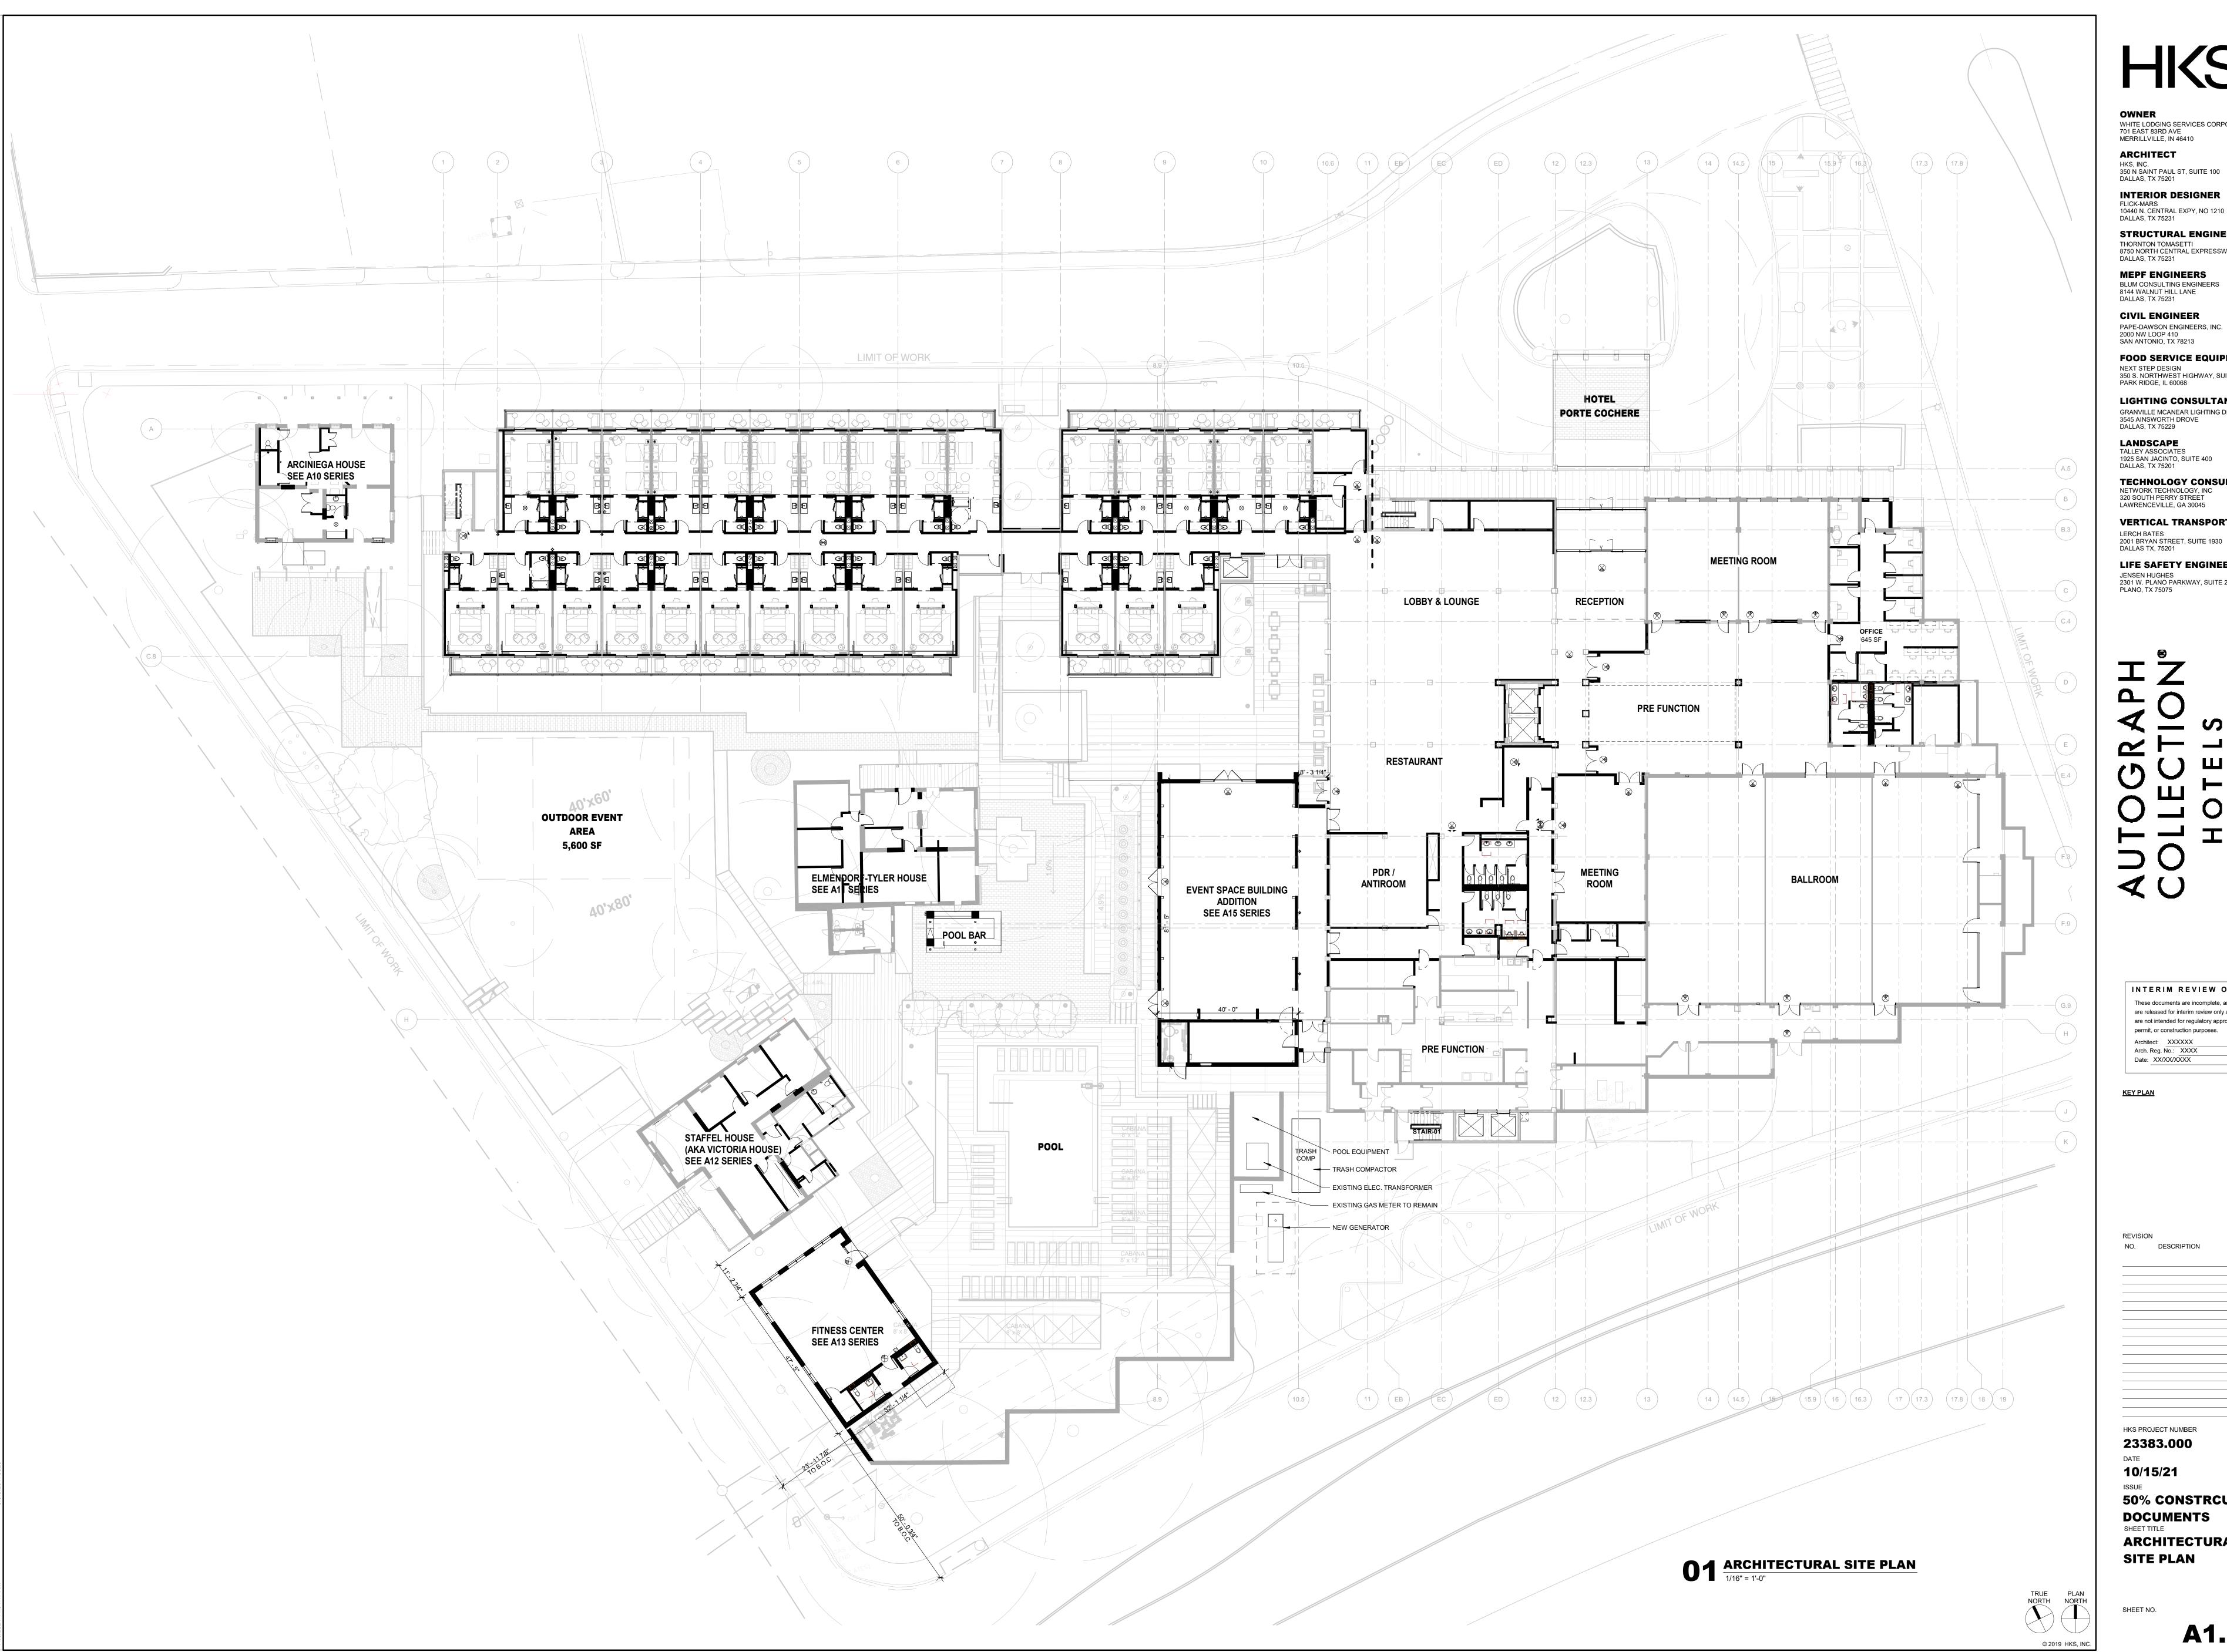350 N SAINT PAUL ST, SUITE 100

DALLAS, TX 75201

10440 N. CENTRAL EXPY, NO 1210 DALLAS, TX 75231 STRUCTURAL ENGINEERS

THORNTON TOMASETTI 8750 NORTH CENTRAL EXPRESSWAY, SUITE 700 DALLAS, TX 75231

MEPF ENGINEERS BLUM CONSULTING ENGINEERS 8144 WALNUT HILL LANE DALLAS, TX 75231

**CIVIL ENGINEER** 

PAPE-DAWSON ENGINEERS, INC. 2000 NW LOOP 410 SAN ANTONIO, TX 78213

**FOOD SERVICE EQUIPMENT** NEXT STEP DESIGN

350 S. NORTHWEST HIGHWAY, SUITE 300 PARK RIDGE, IL 60068

LIGHTING CONSULTANT GRANVILLE MCANEAR LIGHTING DESIGN, LLC 3545 AINSWORTH DROVE DALLAS, TX 75229

LANDSCAPE TALLEY ASSOCIATES

1925 SAN JACINTO, SUITE 400 DALLAS, TX 75201 **TECHNOLOGY CONSULTANT** 

**VERTICAL TRANSPORTATION** LERCH BATES

DALLAS TX, 75201 **LIFE SAFETY ENGINEER** 

JENSEN HUGHES 2301 W. PLANO PARKWAY, SUITE 210 PLANO, TX 75075

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REVISION NO. DESCRIPTION


HKS PROJECT NUMBER

23383.000

**50% CONSTRCUTION DOCUMENTS** 

**ARCHITECTURAL** SITE PLAN

A1.20

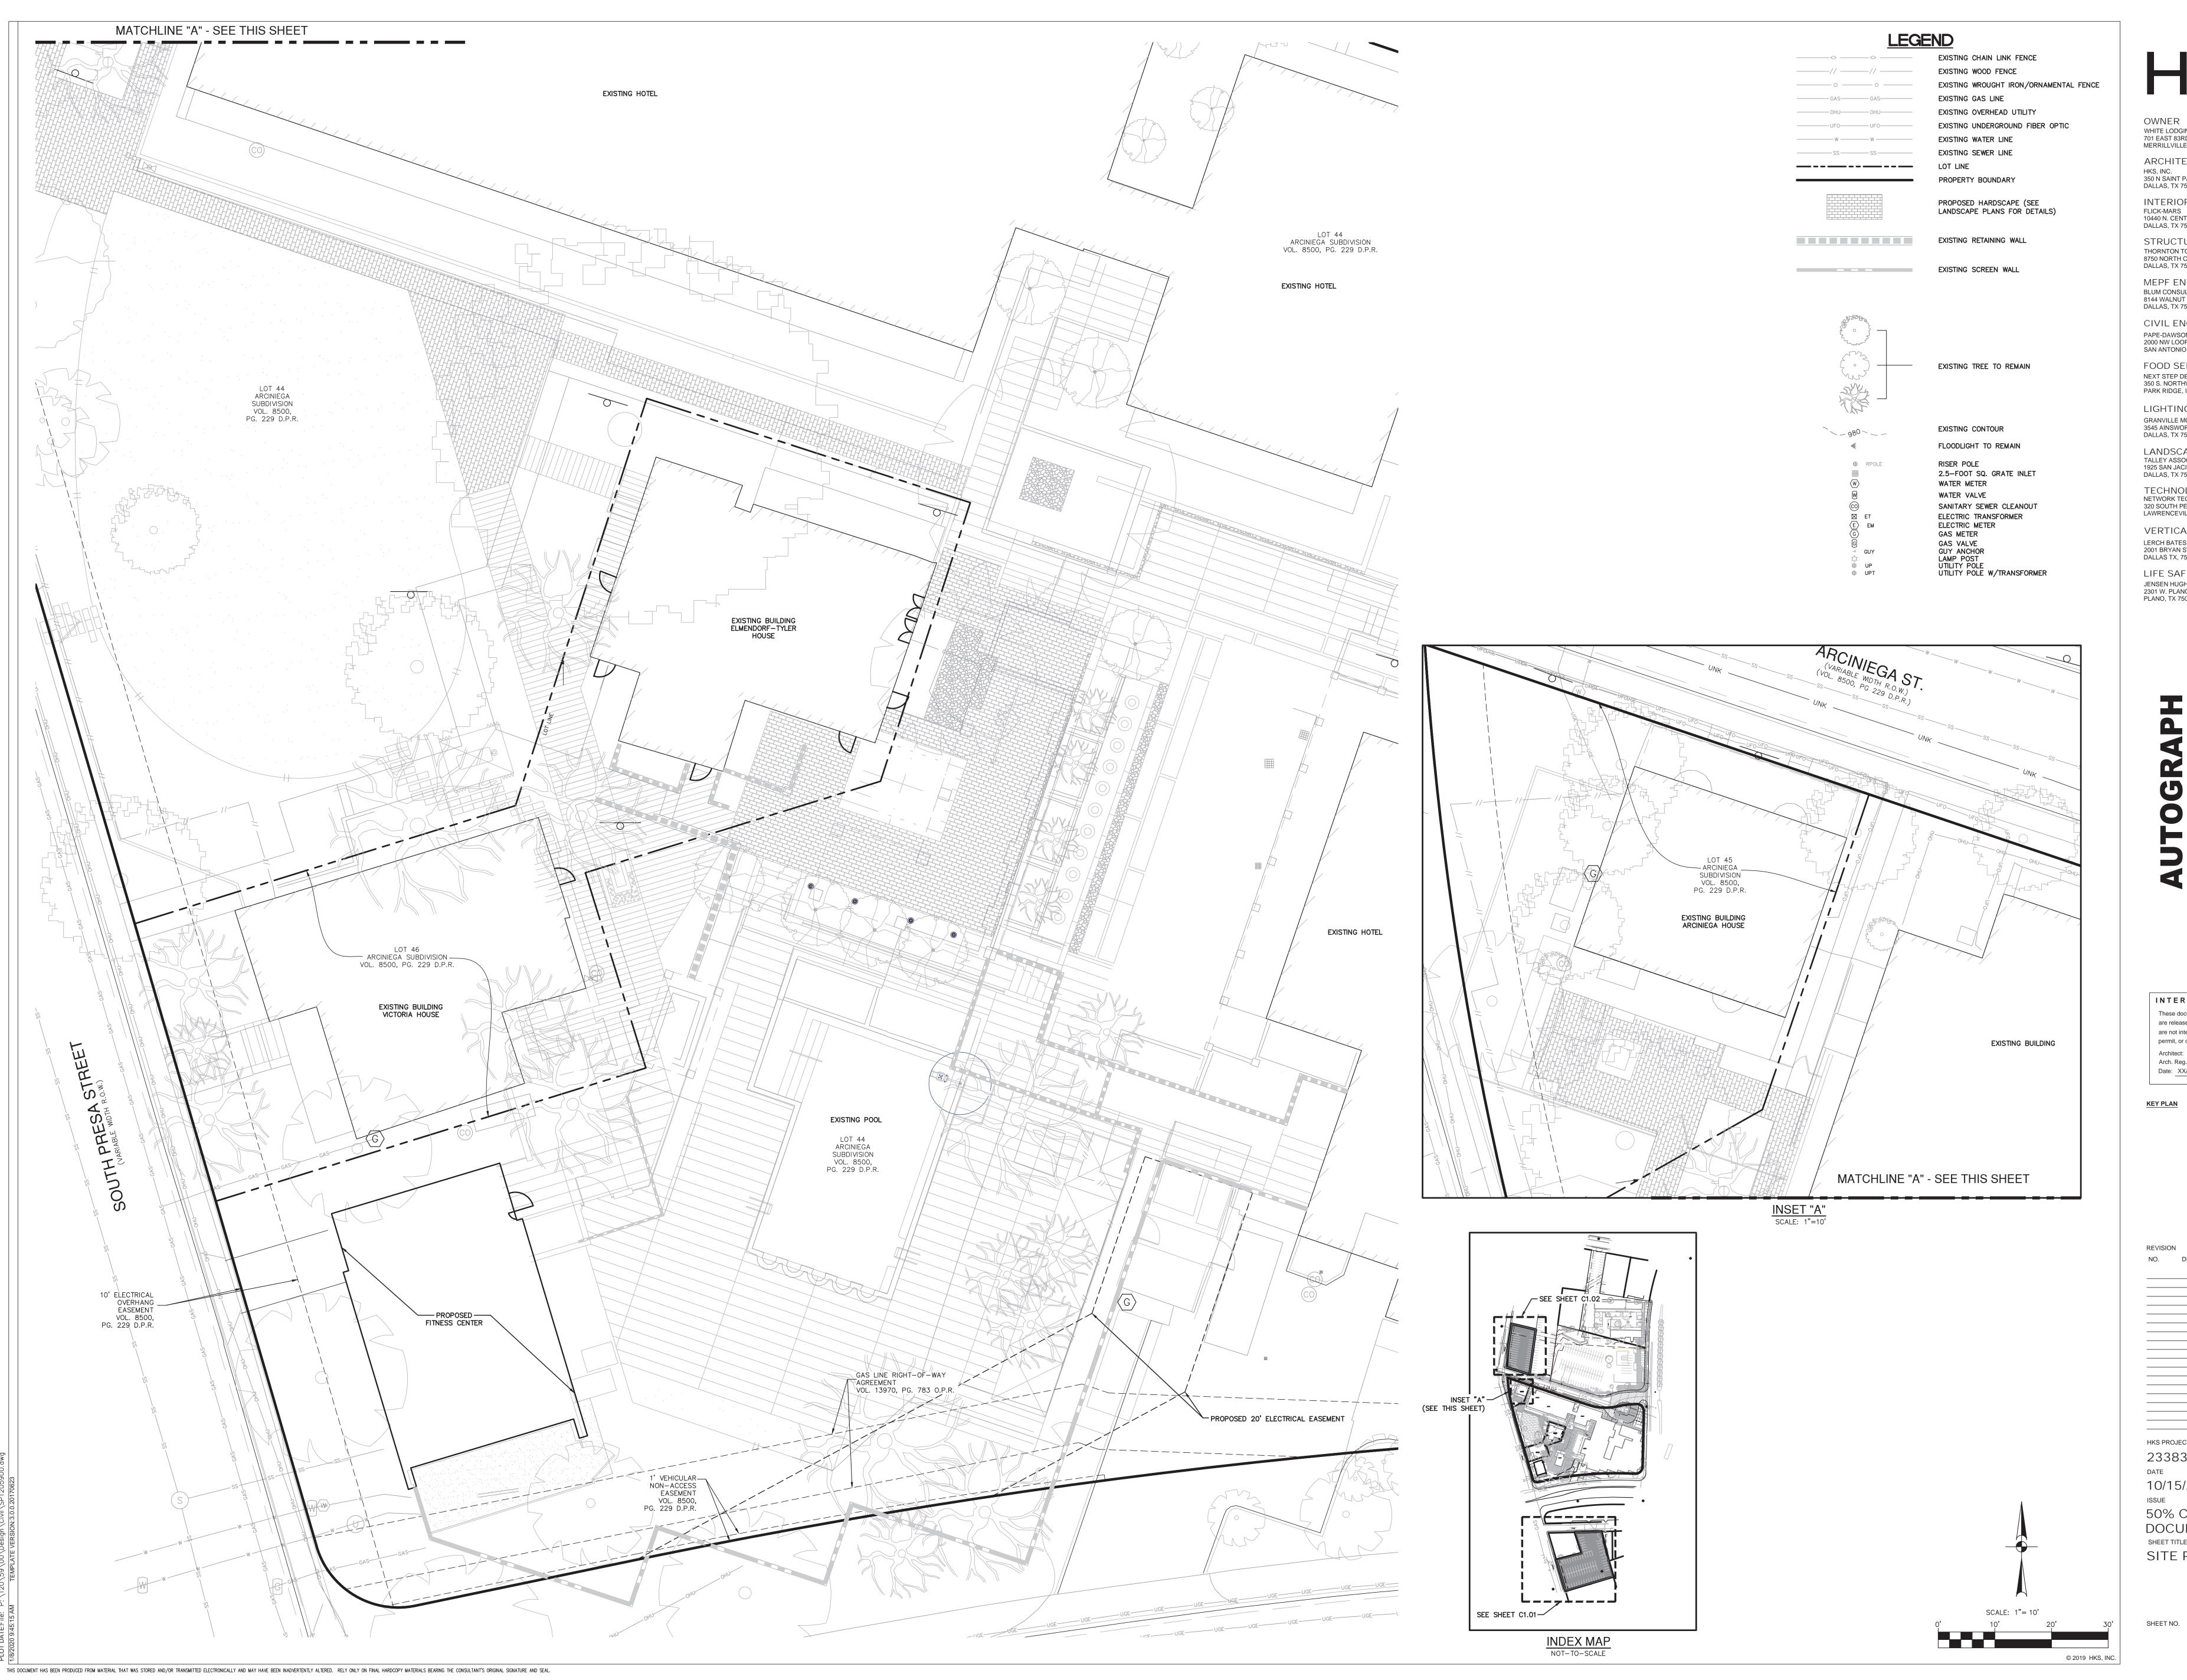

WHITE LODGING SERVICES CORPORATION 701 EAST 83RD AVE

MERRILLVILLE, IN 46410 ARCHITECT HKS, INC.

350 N SAINT PAUL ST, SUITE 100 DALLAS, TX 75201

INTERIOR DESIGNER FLICK-MARS 10440 N. CENTRAL EXPY, NO 1210 DALLAS, TX 75231 STRUCTURAL ENGINEERS

THORNTON TOMASETTI 8750 NORTH CENTRAL EXPRESSWAY, SUITE 700 DALLAS, TX 75231 MEPF ENGINEERS

BLUM CONSULTING ENGINEERS 8144 WALNUT HILL LANE DALLAS, TX 75231 CIVIL ENGINEER PAPE-DAWSON ENGINEERS, INC. 2000 NW LOOP 410 SAN ANTONIO, TX 78213

FOOD SERVICE EQUIPMENT NEXT STEP DESIGN 350 S. NORTHWEST HIGHWAY, SUITE 300

PARK RIDGE, IL 60068 LIGHTING CONSULTANT GRANVILLE MCANEAR LIGHTING DESIGN, LLC 3545 AINSWORTH DROVE DALLAS, TX 75229

LANDSCAPE
TALLEY ASSOCIATES
1925 SAN JACINTO, SUITE 400
DALLAS, TX 75201

TECHNOLOGY CONSULTANT NETWORK TECHNOLOGY, INC 320 SOUTH PERRY STREET

LAWRENCEVILLE, GA 30045 VERTICAL TRANSPORTATION LERCH BATES 2001 BRYAN STREET, SUITE 1930 DALLAS TX, 75201

> LIFE SAFETY ENGINEER JENSEN HUGHES 2301 W. PLANO PARKWAY, SUITE 210 PLANO, TX 75075

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**KEY PLAN** 

Date: XX/XX/XXXXX

REVISION


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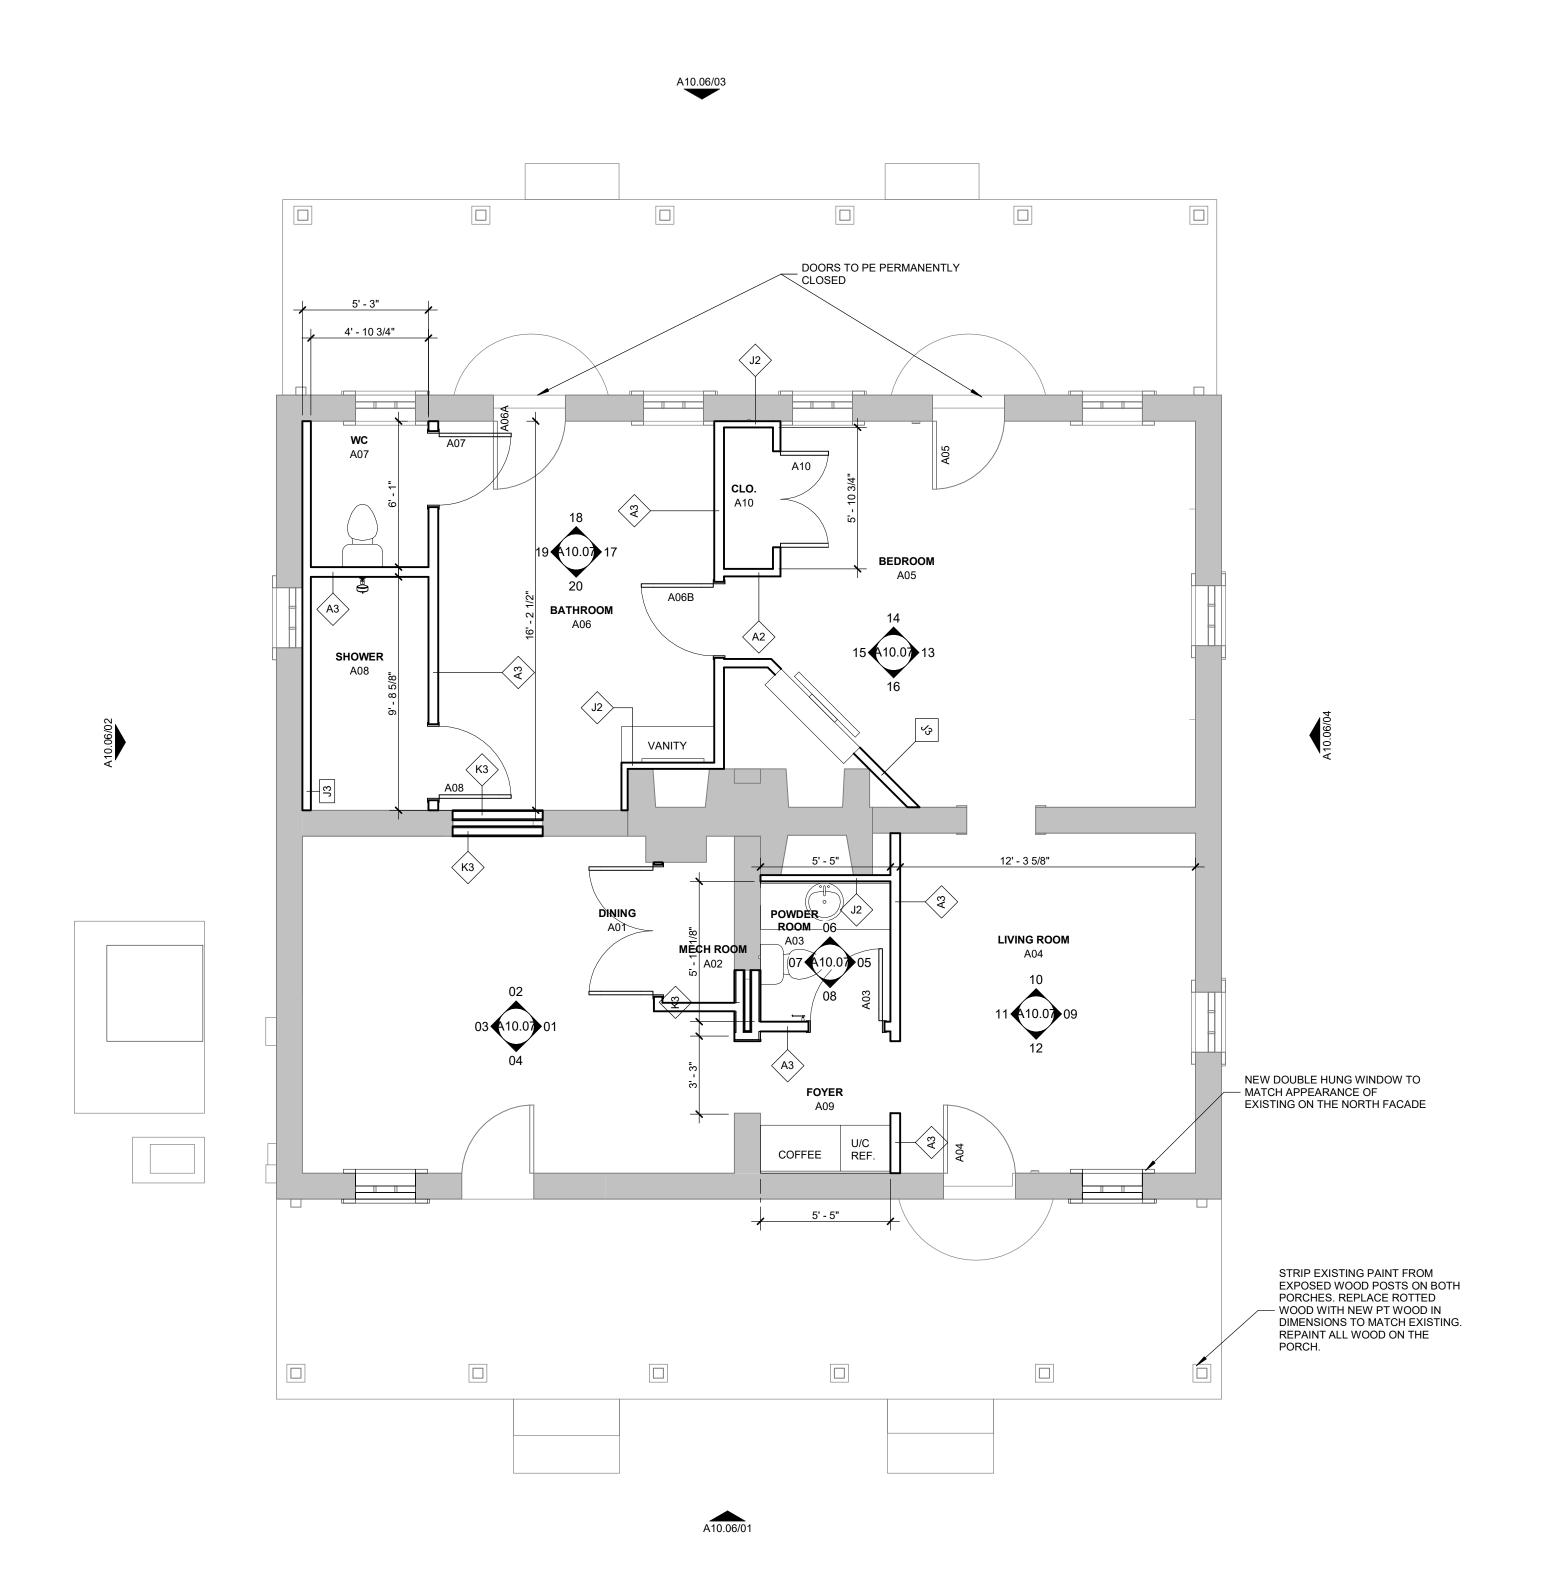
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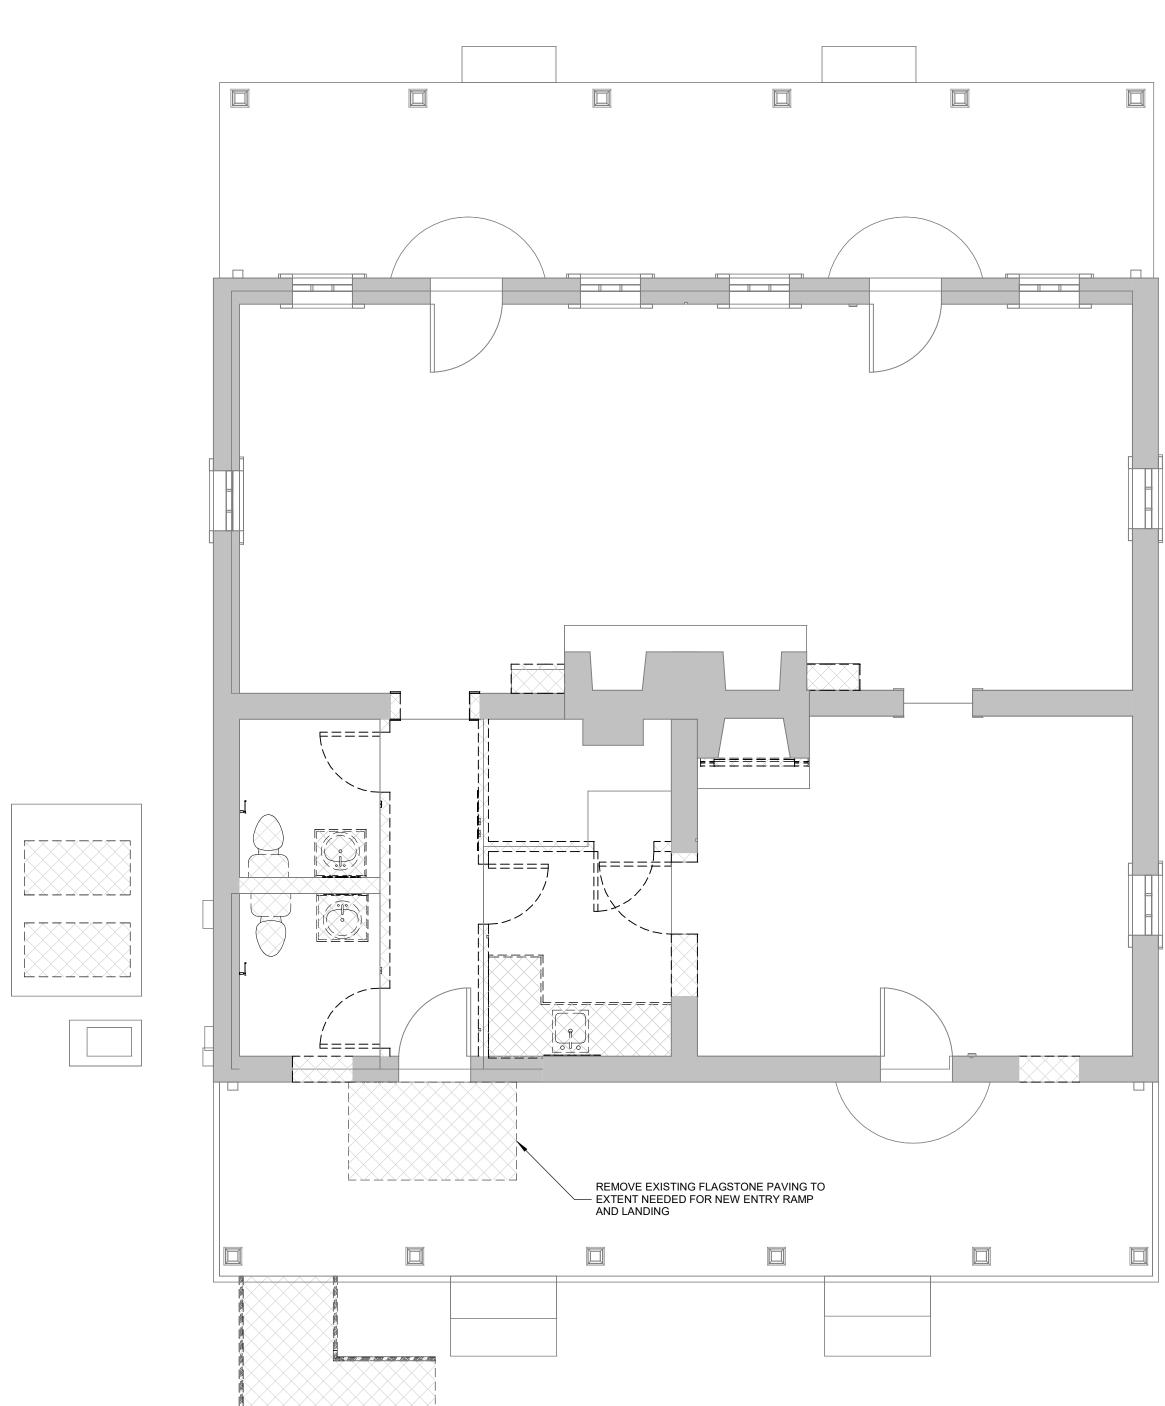
DATE 10/15/2021

50% CONSTRUCTION DOCUMENTS SHEET TITLE SITE PLAN







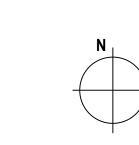







WHITE LODGING SERVICES CORPORATION 701 EAST 83RD AVE MERRILLVILLE, IN 46410

**ARCHITECT** HKS, INC.

350 N SAINT PAUL ST, SUITE 100 DALLAS, TX 75201

INTERIOR DESIGNER FLICK-MARS

10440 N. CENTRAL EXPY, NO 1210

DALLAS, TX 75231

STRUCTURAL ENGINEERS THORNTON TOMASETTI 8750 NORTH CENTRAL EXPRESSWAY, SUITE 700

DALLAS, TX 75231 **MEPF ENGINEERS** 

BLUM CONSULTING ENGINEERS 8144 WALNUT HILL LANE DALLAS, TX 75231

**CIVIL ENGINEER** PAPE-DAWSON ENGINEERS, INC.

2000 NW LOOP 410 SAN ANTONIO, TX 78213

FOOD SERVICE EQUIPMENT NEXT STEP DESIGN

350 S. NORTHWEST HIGHWAY, SUITE 300 PARK RIDGE, IL 60068

LIGHTING CONSULTANT GRANVILLE MCANEAR LIGHTING DESIGN, LLC

3545 AINSWORTH DROVE DALLAS, TX 75229

LANDSCAPE TALLEY ASSOCIATES

1925 SAN JACINTO, SUITE 400 DALLAS, TX 75201 **TECHNOLOGY CONSULTANT** 

NETWORK TECHNOLOGY, INC 320 SOUTH PERRY STREET LAWRENCEVILLE, GA 30045

**VERTICAL TRANSPORTATION** LERCH BATES 2001 BRYAN STREET, SUITE 1930

DALLAS TX, 75201 **LIFE SAFETY ENGINEER** 

JENSEN HUGHES 2301 W. PLANO PARKWAY, SUITE 210 PLANO, TX 75075

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Date: XX/XX/XXXX

KEY PLAN

REVISION NO. DESCRIPTION

HKS PROJECT NUMBER


**NEW PLAN** 

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23383.000 10/15/21


**50% CONSTRCUTION DOCUMENTS ARCINIEGA HOUSE DEMOLITION PLAN &** 

A10.02

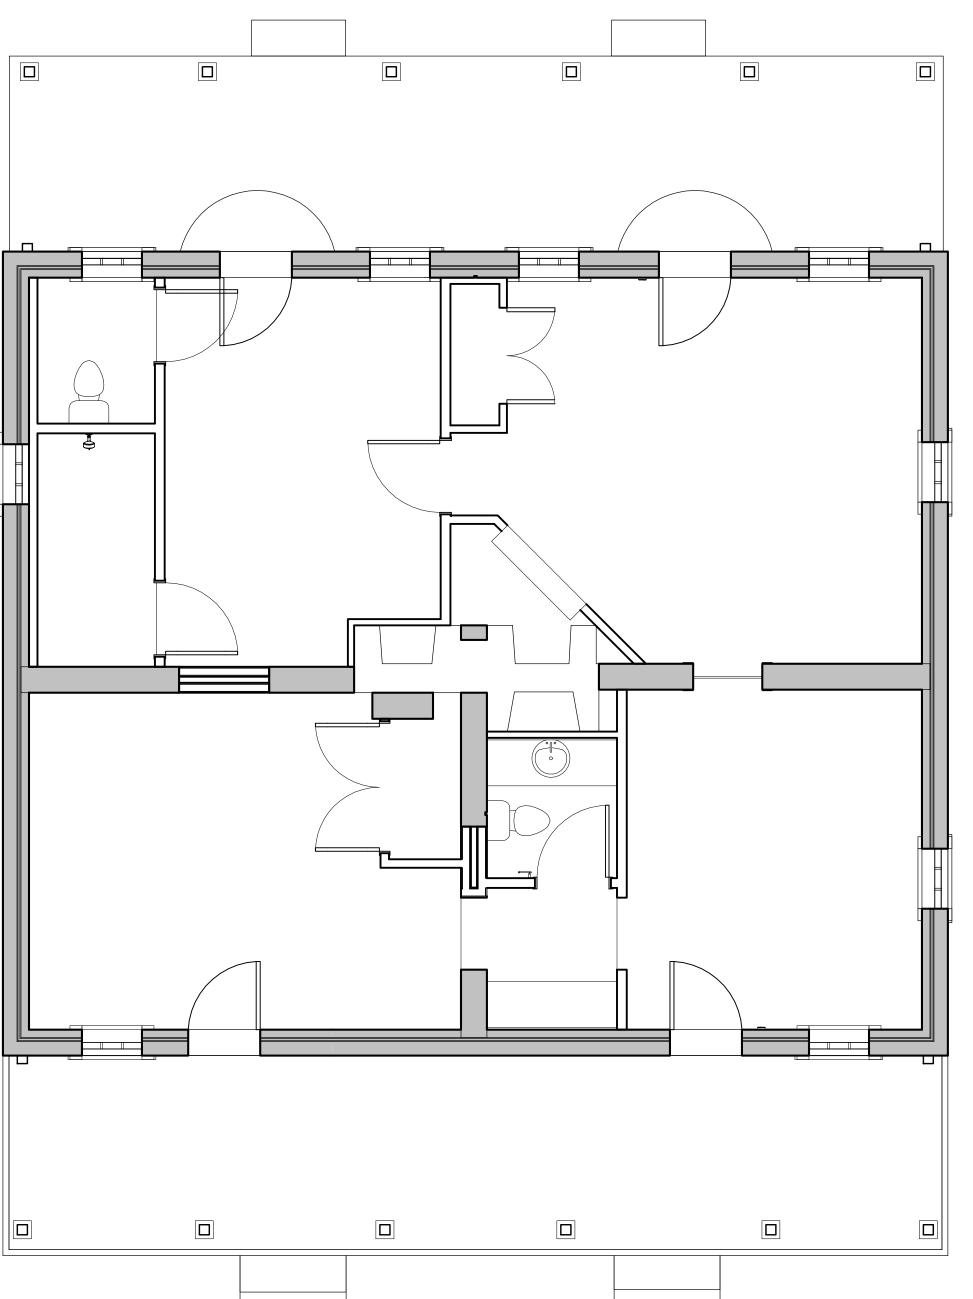


02 FINISH PLAN - ARCINIEGA HOUSE

1/4" = 1'-0"

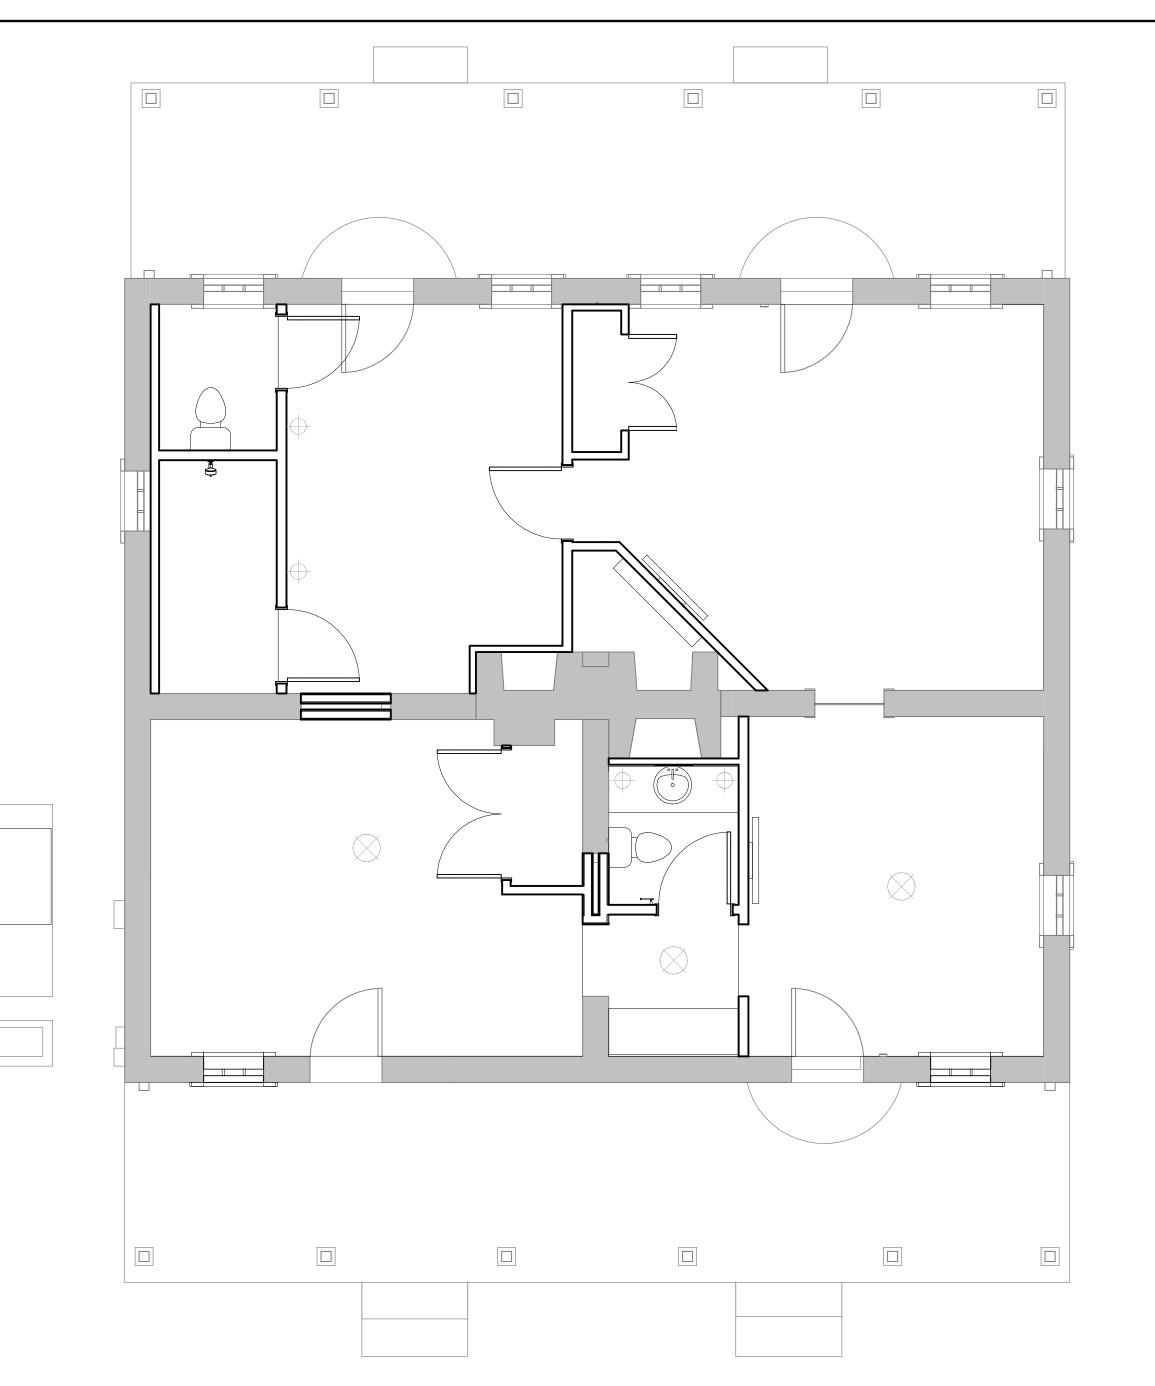

PLAN	ELEVATION	DESCRIPTION
<b>—</b>	0 0	DUPLEX ELECTRICAL
⇒:	0	DUPLEX ELECTRICAL + 2 USB PORTS
#	0 0 0	QUAD ELECTRICAL
☐ GFI	0 0	DUPLEX ELECTRICAL (GFI)
⇒ GFI	0 0	QUAD ELECTRICAL (GFI)
•	0	DUPLEX OUTLET (FLOOR)
J		JUNCTION BOX
$\leftarrow$	1	SWITCH
<b>#</b>	I	3-WAY SWITCH
$\leftarrow$ M	I	MASTER SWITCH
$\rightarrow \!$	0	SWITCH (DIMMER)
<b>-</b> → J	I	DOOR JAMB SWITCH
T		THERMOSTAT
		DATA PORT
		TELEPHONE PORT
<b>~</b>	0	TELEPHONE / DATA PORT
	0	VOICE / DATA FLOOR OUTLET
$\rightarrow$	-	USB PORT
TV		TELEVISION COAX
DB	0	VISIBLE NOTIFICATION DEVICE BUTTO
VND\$-		VISIBLE NOTIFICATION DEVICE
F⊲		FIRE ALARM SPEAKER
F -		FIRE ALARM STROBE
	FA	CEILING FIRE ALARM STROBE
≪∏FL		FIRE ALARM SPEAKER & STROBE
$\rightarrow$		SMOKE DETECTOR
Ю-		WALL MOUNTED LIGHT FIXTURE
Φ		PENDANT LIGHT FIXTURE
0		RECESSED DOWN LIGHT
<b>→</b>		WALL WASHER LIGHT
		SUPPLY AIR DIFFUSER
		RETURN AIR DIFFUSER
		EXHAUST AIR DIFFUSER
		CEILING ACCESS PANEL
K	*	WALL MOUNTED SPRINKLER HEAD
	*	CEILING SPRINKLER HEAD
ЮS	OS	WALL MOUNTED OCCUPANCY SENSOI
	(OS)	OCCUPANCY SENSOR

03 MEP COORDINATION PLAN - ARCINIEGA HOUSE

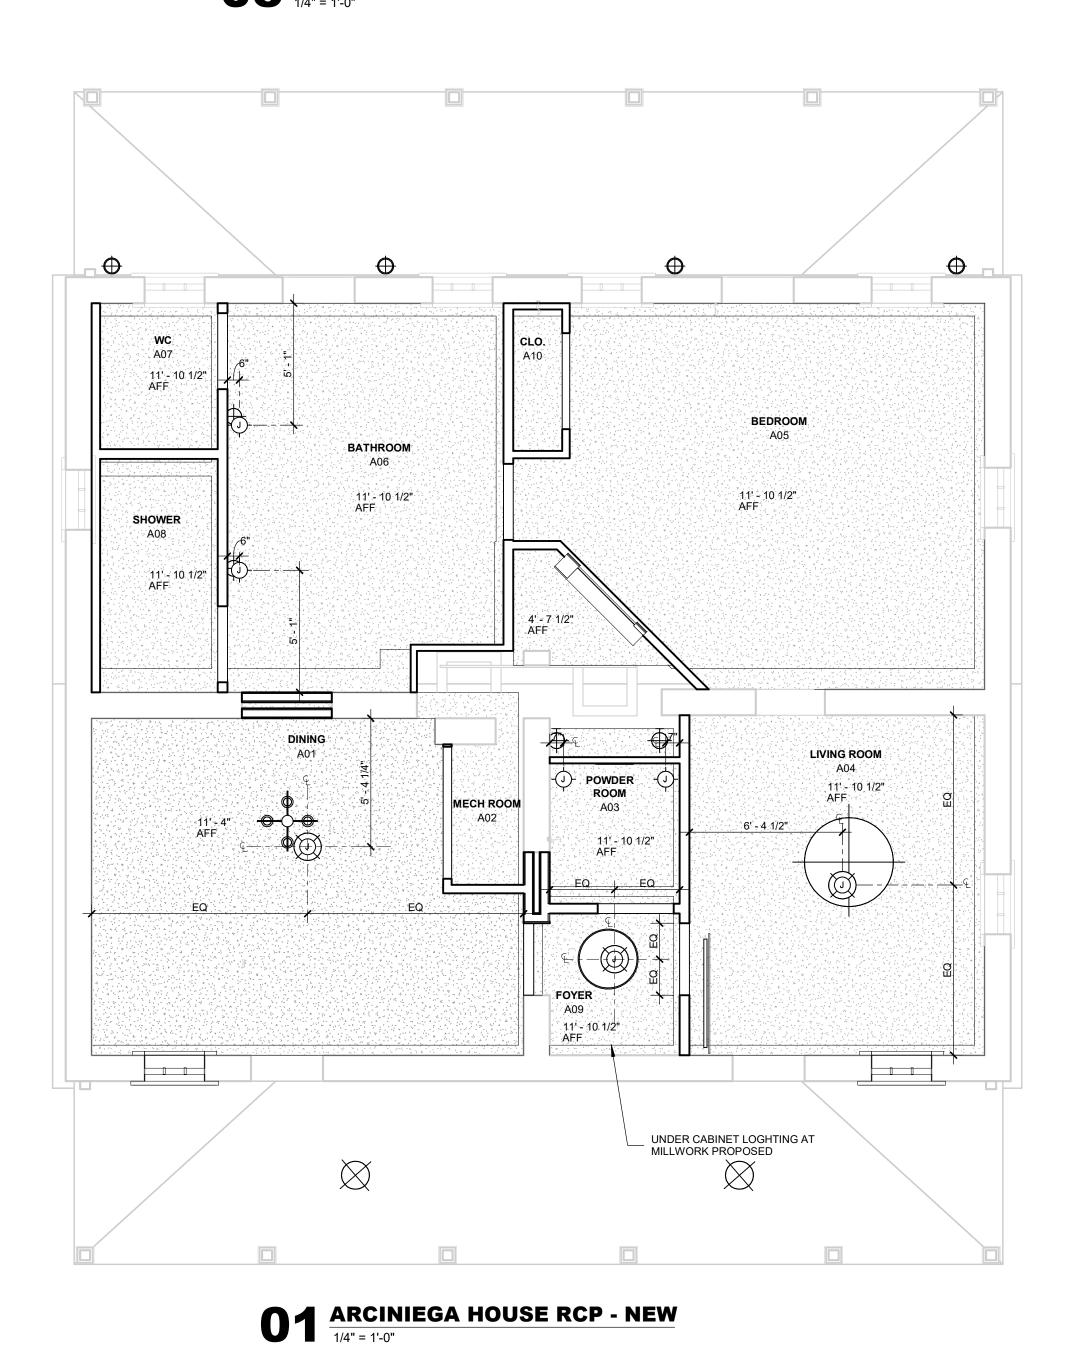

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Architect: XXXXXX Arch. Reg. No.: XXXX Date: XX/XX/XXXX

WHITE LODGING SERVICES CORPORATION

701 EAST 83RD AVE MERRILLVILLE, IN 46410

350 N SAINT PAUL ST, SUITE 100

INTERIOR DESIGNER

10440 N. CENTRAL EXPY, NO 1210

STRUCTURAL ENGINEERS

THORNTON TOMASETTI 8750 NORTH CENTRAL EXPRESSWAY, SUITE 700

**ARCHITECT** 

DALLAS, TX 75201

FLICK-MARS

DALLAS, TX 75231

DALLAS, TX 75231

**MEPF ENGINEERS** 

**CIVIL ENGINEER** 

2000 NW LOOP 410 SAN ANTONIO, TX 78213

NEXT STEP DESIGN

PARK RIDGE, IL 60068

3545 AINSWORTH DROVE DALLAS, TX 75229

1925 SAN JACINTO, SUITE 400

NETWORK TECHNOLOGY, INC 320 SOUTH PERRY STREET LAWRENCEVILLE, GA 30045

LANDSCAPE TALLEY ASSOCIATES

DALLAS, TX 75201

BLUM CONSULTING ENGINEERS 8144 WALNUT HILL LANE DALLAS, TX 75231

PAPE-DAWSON ENGINEERS, INC.

FOOD SERVICE EQUIPMENT

350 S. NORTHWEST HIGHWAY, SUITE 300

GRANVILLE MCANEAR LIGHTING DESIGN, LLC

**TECHNOLOGY CONSULTANT** 

LIGHTING CONSULTANT

KEY PLAN

HKS PROJECT NUMBER 23383.000


10/15/21 **50% CONSTRCUTION DOCUMENTS** 


**ARCINIEGA HOUSE-**RCP, FINSH, ROOF & **MEP COORDINATION** PLAN

A10.03


**VERTICAL TRANSPORTATION** LERCH BATES 2001 BRYAN STREET, SUITE 1930 DALLAS TX, 75201 LIFE SAFETY ENGINEER JENSEN HUGHES 2301 W. PLANO PARKWAY, SUITE 210 PLANO, TX 75075

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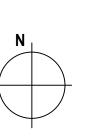
 $03^{\frac{\text{EXISTING - ARCINIEGA HOUSE - SOUTH ELEVATION}}{1/4" = 1'-0"}$ 

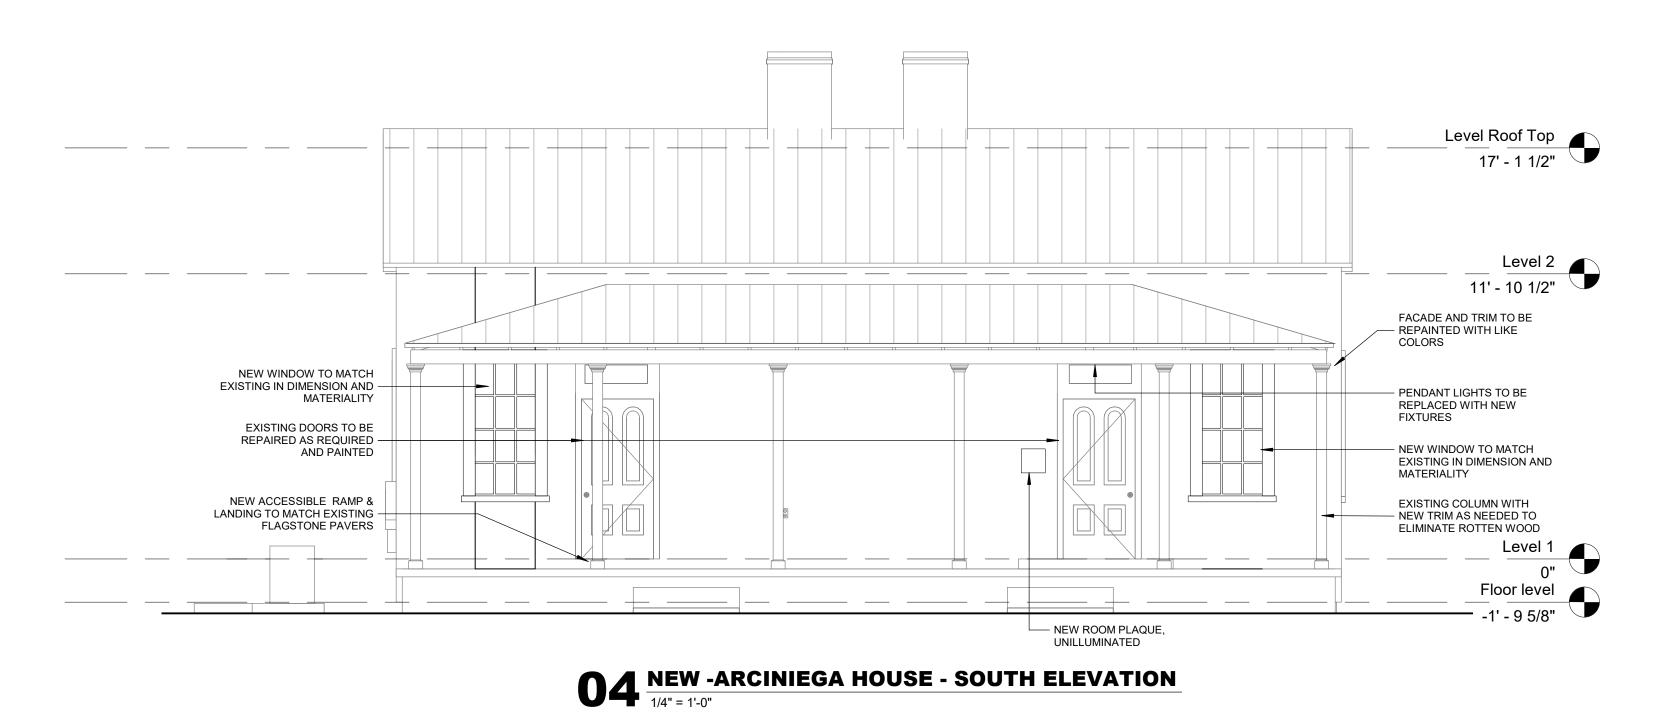

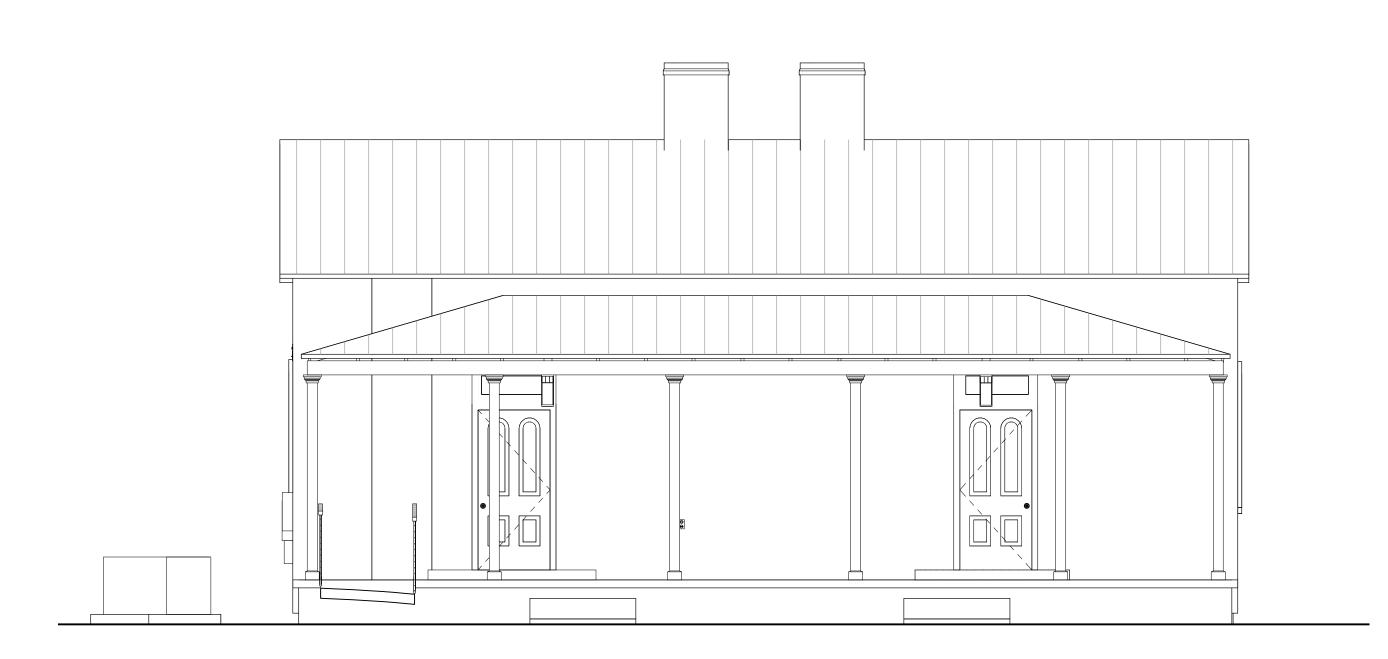DOORS TO PE PERMANENTLY 5' - 3" 4' - 10 3/4" BATHROOM 12' - 3 5/8" MECH ROOM LIVING ROOM A01 NEW DOUBLE HUNG WINDOW TO MATCH APPEARANCE OF
 EXISTING ON THE NORTH FACADE 5' - 5" NEW DOUBLE HUNG WINDOW TO MATCH APPEARANCE OF – EXISTING ON THE NORTH FACADE EXISTING ENTRY DOORS TO REMAIN. DOORS TO BE REPAIRED AS NEEDED EXISTING ENTRY DOORS TO REMAIN. AND PAINTED. NEW HARDWARE DOORS TO BE REPAIRED AS NEEDED AND PAINTED. NEW HARDWARE STRIP EXISTING PAINT FROM EXPOSED WOOD POSTS ON BOTH PORCHES. REPLACE ROTTED — WOOD WITH NEW PT WOOD IN DIMENSIONS TO MATCH EXISTING. REPAINT ALL WOOD ON THE PORCH.

**NEW CONSTRUCTION - ARCINIEGA HOUSE FLOOR PLAN**1/4" = 1'-0"

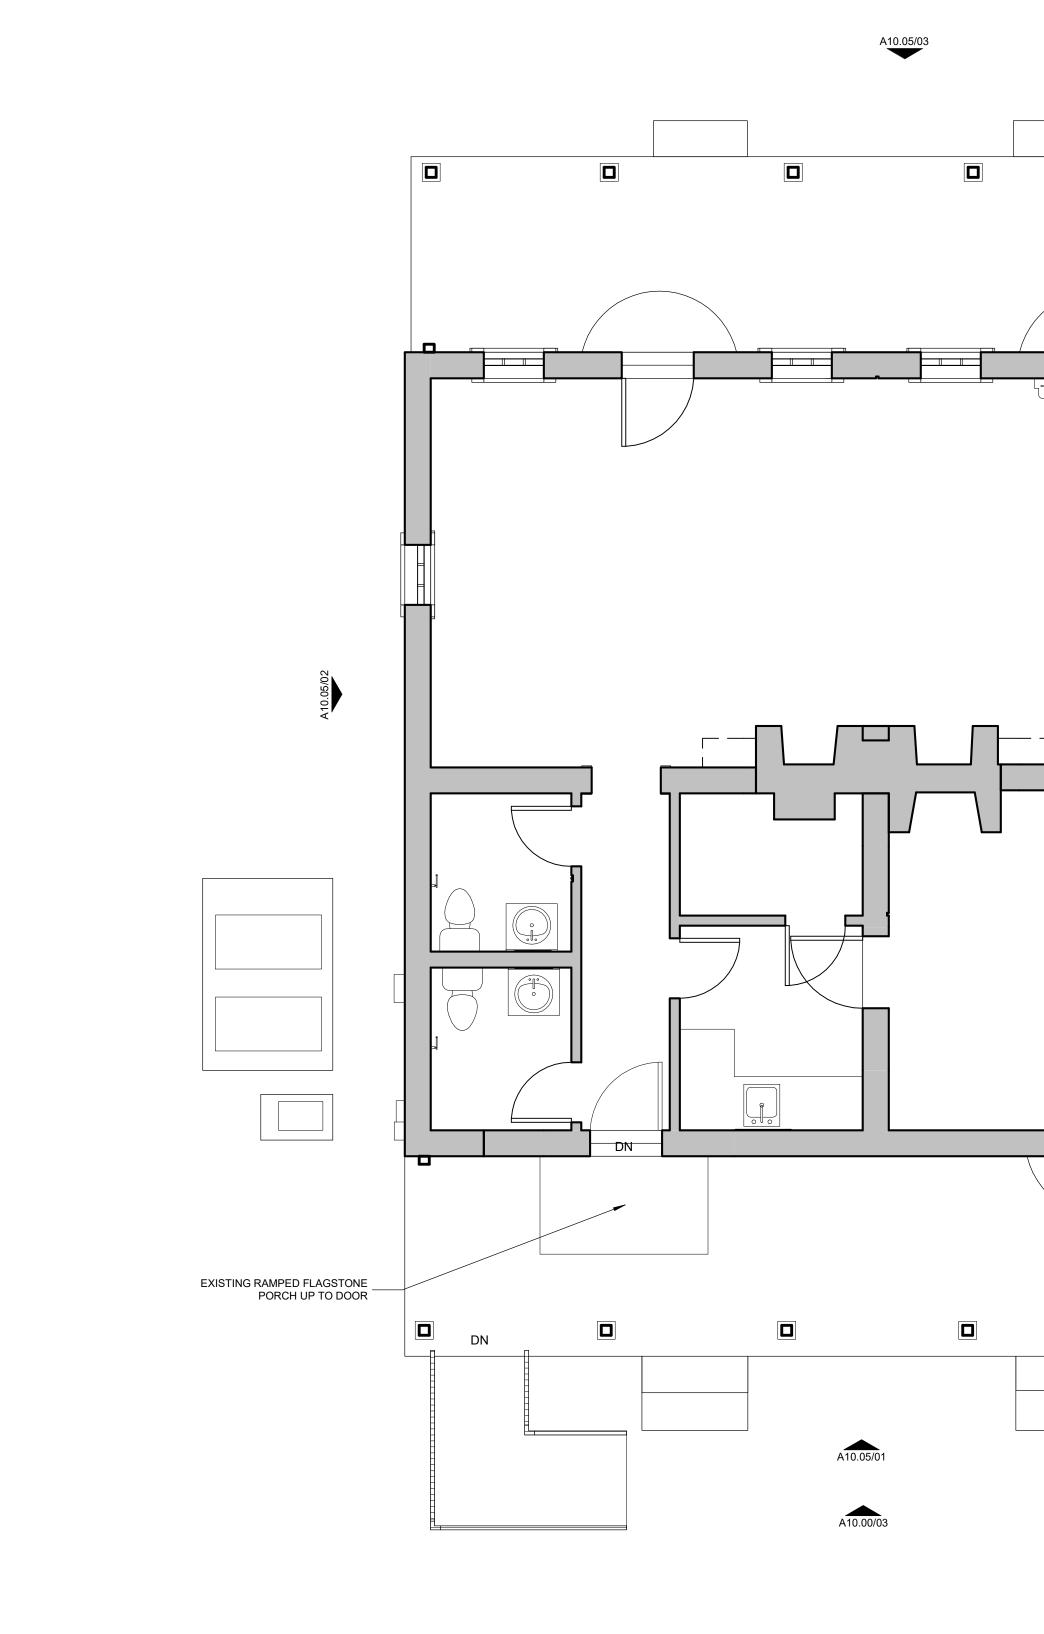O1 EXISTING -ARCINIEGA HOUSE - PLAN 1/4" = 1'-0"



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WHITE LODGING SERVICES CORPORATION 701 EAST 83RD AVE MERRILLVILLE, IN 46410

**ARCHITECT** HKS, INC.

350 N SAINT PAUL ST, SUITE 100 DALLAS, TX 75201

INTERIOR DESIGNER FLICK-MARS 10440 N. CENTRAL EXPY, NO 1210

DALLAS, TX 75231 STRUCTURAL ENGINEERS THORNTON TOMASETTI 8750 NORTH CENTRAL EXPRESSWAY, SUITE 700

DALLAS, TX 75231 **MEPF ENGINEERS** BLUM CONSULTING ENGINEERS

8144 WALNUT HILL LANE DALLAS, TX 75231

**CIVIL ENGINEER** PAPE-DAWSON ENGINEERS, INC. 2000 NW LOOP 410

SAN ANTONIO, TX 78213

FOOD SERVICE EQUIPMENT NEXT STEP DESIGN 350 S. NORTHWEST HIGHWAY, SUITE 300

PARK RIDGE, IL 60068 LIGHTING CONSULTANT

GRANVILLE MCANEAR LIGHTING DESIGN, LLC 3545 AINSWORTH DROVE DALLAS, TX 75229

**TECHNOLOGY CONSULTANT** 

**LANDSCAPE** TALLEY ASSOCIATES

1925 SAN JACINTO, SUITE 400 DALLAS, TX 75201

320 SOUTH PERRY STREET LAWRENCEVILLE, GA 30045

**VERTICAL TRANSPORTATION** LERCH BATES 2001 BRYAN STREET, SUITE 1930

NETWORK TECHNOLOGY, INC

DALLAS TX, 75201

LIFE SAFETY ENGINEER JENSEN HUGHES 2301 W. PLANO PARKWAY, SUITE 210 PLANO, TX 75075

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**KEY PLAN** 

Date: XX/XX/XXXX

REVISION NO. DESCRIPTION

HKS PROJECT NUMBER 23383.000

10/15/21

**50% CONSTRCUTION DOCUMENTS ARCINIEGA HOUSE-SOUTH PORCH** 

**RENOVATIONS** 




A10.06

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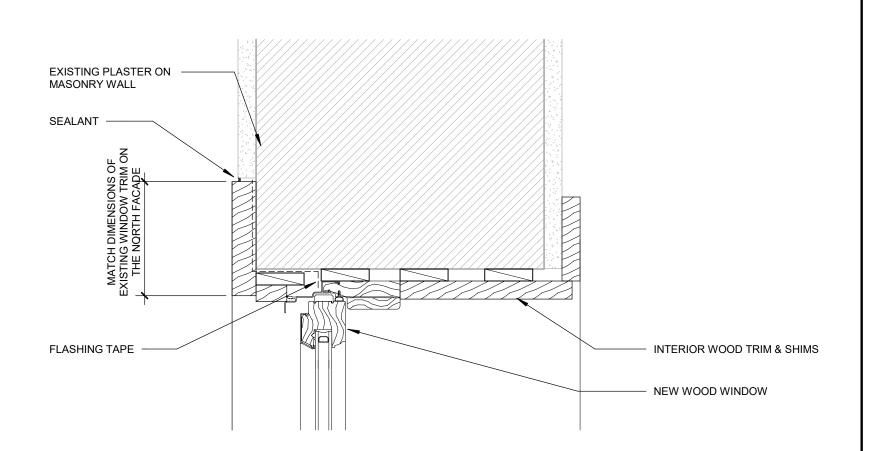
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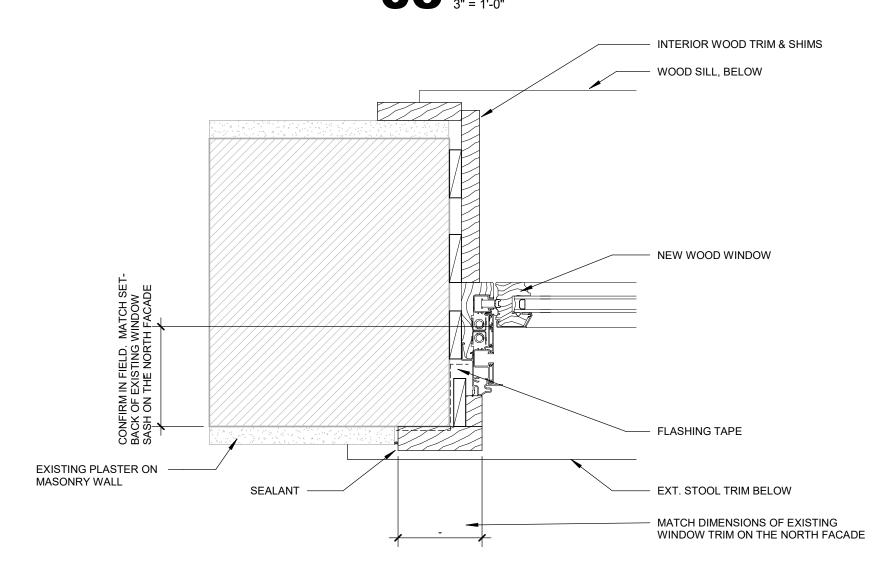
WHITE LODGING SERVICES CORPORATION




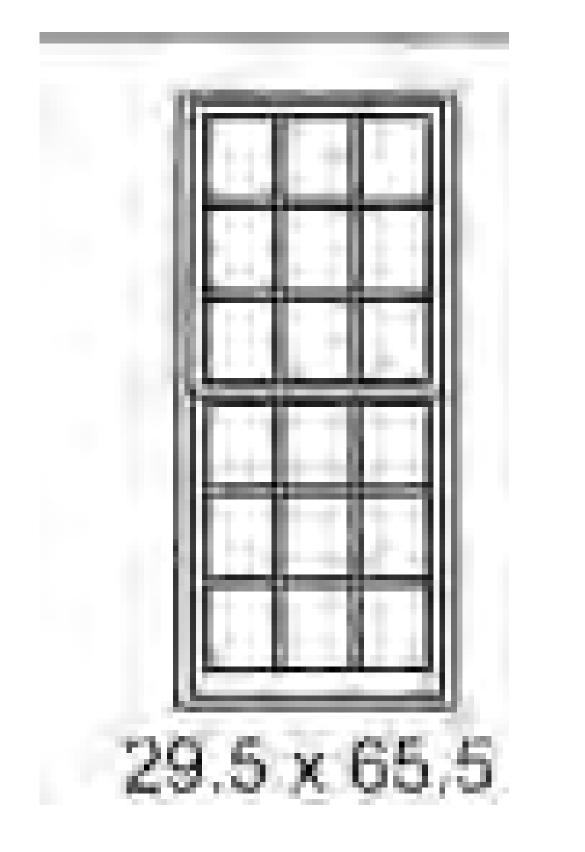

04 ARCINIEGA HOUSE WINDOW DETAIL
1 1/2" = 1'-0"





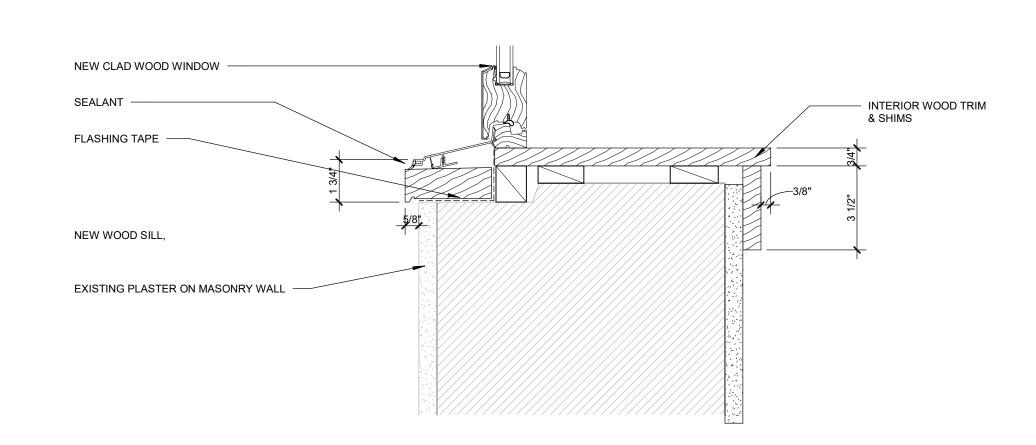

O1 CS-WINDOW SILL DETAIL
3" = 1'-0"

WHITE LODGING SERVICES CORPORATION 701 EAST 83RD AVE MERRILLVILLE, IN 46410

**ARCHITECT** HKS, INC. 350 N SAINT PAUL ST, SUITE 100 DALLAS, TX 75201

INTERIOR DESIGNER

FLICK-MARS 10440 N. CENTRAL EXPY, NO 1210 DALLAS, TX 75231 STRUCTURAL ENGINEERS

THORNTON TOMASETTI 8750 NORTH CENTRAL EXPRESSWAY, SUITE 700 DALLAS, TX 75231 MEPF ENGINEERS

BLUM CONSULTING ENGINEERS 8144 WALNUT HILL LANE DALLAS, TX 75231 **CIVIL ENGINEER** 

PAPE-DAWSON ENGINEERS, INC. 2000 NW LOOP 410 SAN ANTONIO, TX 78213

FOOD SERVICE EQUIPMENT

NEXT STEP DESIGN 350 S. NORTHWEST HIGHWAY, SUITE 300 PARK RIDGE, IL 60068 LIGHTING CONSULTANT

GRANVILLE MCANEAR LIGHTING DESIGN, LLC 3545 AINSWORTH DROVE DALLAS, TX 75229

LANDSCAPE TALLEY ASSOCIATES 1925 SAN JACINTO, SUITE 400 DALLAS, TX 75201

TECHNOLOGY CONSULTANT NETWORK TECHNOLOGY, INC 320 SOUTH PERRY STREET LAWRENCEVILLE, GA 30045

VERTICAL TRANSPORTATION LERCH BATES 2001 BRYAN STREET, SUITE 1930

DALLAS TX, 75201

LIFE SAFETY ENGINEER JENSEN HUGHES 2301 W. PLANO PARKWAY, SUITE 210 PLANO, TX 75075

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**KEY PLAN** 


REVISION

HKS PROJECT NUMBER 23383.000 10/26/21

**ARCINIEGA HOUSE-RENOVATION DETAILS** 

SHEET NO. A10.08

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MATERIAL LEGEND

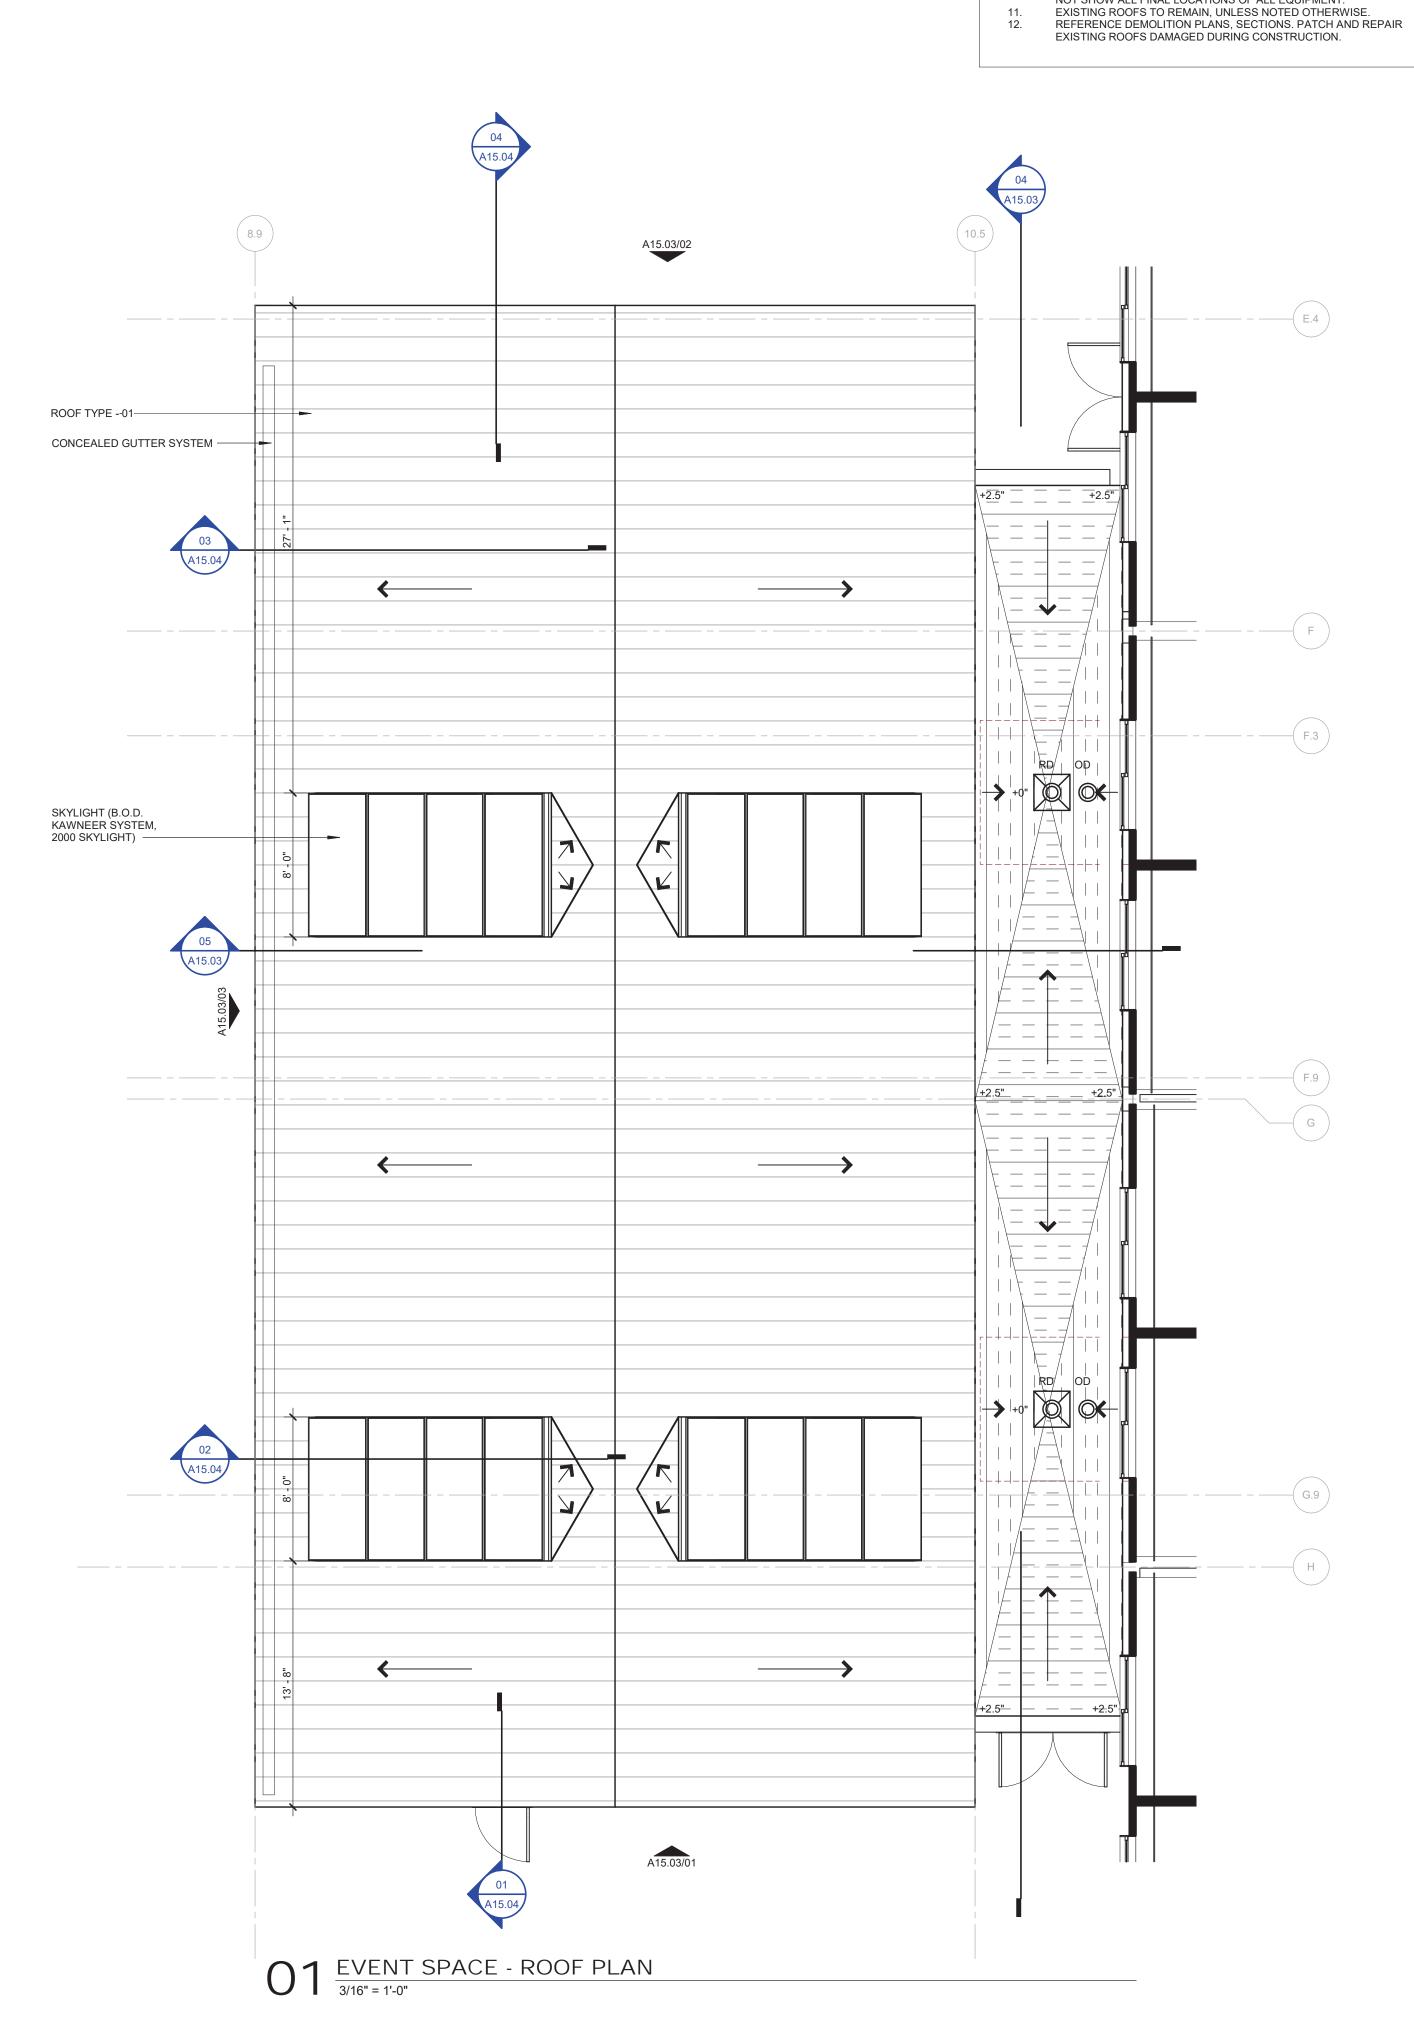GENERAL NOTES - ROOF PLAN

ROOF TYPES ARE AS FOLLOWS: ROOF TYPE 1: FIELD FABRICATED STANDING SEAM METAL ROOF. ROOF TYPE 2: SINGLE PLY MEMBRANE.

ALL ROOFING SURFACES TO SLOPE 1/4" VERTICAL PER 1' - 0" HORIZONTAL MINIMUM, UNLESS NOTED OTHERWISE. HATCHING INDICATES AREAS WHERE THE ROOF SURFACE SLOPE IS

ACHIEVED WITH TAPERED INSULATION. THE ROOF SURFACE SLOPE IN AREAS WITHOUT HATCHING IS ACHIEVED WITH SLOPING STRUCTURE. TOP OF INSULATION HEIGHTS, HIGH POINTS AND LOW POINTS, ARE INDICATED AS THE TOP OF ROOF SURFACE ABOVE THE ROOF DRAIN(S). (I.E.+ 3.5" WHERE HIGH POINT OF ROOF DRAIN SUMP IS +0").

REFER TO SHEET A7.10 FOR TYPICAL ROOF DETAILS. ALL ROOF TOP MECHANICAL, ELECTRICAL AND/OR PLUMBING EQUIPMENT SHOWN FOR INFORMATION ONLY. REFERENCE MECHANICAL, ELECTRICAL AND PLUMBING DOCUMENTS

AND SPECIFICATIONS FOR SPECIFIC DESIGN INFORMATION. PROVIDE WALKWAY PROTECTION TO MAJOR MECHANICAL, ELECTRICAL AND PLUMBING EQUIPMENT AS REQUIRED TO PROVIDE SERVICE WALKWAY PROTECTION IS INDICATED AS A GENERAL LAYOUT AND MAY NOT SHOW ALL FINAL LOCATIONS OF ALL EQUIPMENT.

**EXTERIOR INSULATING SYSTEM - EIFS** EIFS-01 EXTERIOR INSULATING FINISH SYSTEM

AMF-01 - GRAPHITE GRAY

AMF-02 - ZINC AMF-03 - STAINLESS STEEL

ARCHITECTURAL METAL FINISH

ARCHITECTURAL EXPOSED STRUCTURAL STEEL

COLOR: TBD

AESS-01 EXPOSED STRUCTURAL STEEL

FINISH: HIGH PERFORMANCE COATING FOR STEEL

**DIRECT-APPLIED EXTERIOR FINISHING SYSTEM - DEFS SOFFITS** DEFS-01 EXTERIOR FINISH SYSTEM FOR SOFFITS

TEXTURE: TBD

**EXTERIOR GLAZING - GL** 

GL-01 INSULATED COATED GLASS - VISION 1" INSULATED / LOW-E VISION GLASS BASIS OF DESIGN: VIRACON VRE 1-54 LOCATION: GUESTROOM TOWER

LOCATION: PODIUM

GL-02 INSULATED COATED GLASS - VISION 1" INSULATED / LOW-E ULTRA CLEAR VISION GLASS BASIS OF DESIGN: VIRACON VE1-85 [CLEAR GLASS]

GL-03 INSULATED / LAMINATED / TEMPERED COATED GLASS
OVERALL THICKNESS: 1-1/2" NOMINAL. OUTBOARD LITE: ½" OUTBOARD LITE INTERLAYER: .060" CLEAR PVB OUTBOARD LITE: CLEAR HS; 1/4" THICK GLASS. AIR SPACE: 1/2"; BLACK FINISH SPACER; BLACK SEALANT. INBOARD LITE: CLEAR HS; 1/4" THICK GLASS. INBOARD CERAMIC FRIT: DARK GREY DOT FRIT 50% INBOARD LITE: CLEAR HS; 1/4" THICK GLASS.

BASIS OF DESIGN MANUFACTURER AND PRODUCT: VIRACON

FIBER CEMENT PANELS

FRC-01 FITNESS BUILDING FACADE BASIS OF DESIGN: NICHIHA FORMAT: WALL PANEL TEXTURE: WOOD SERIES; VINTAGEWOOD

FINISH COLOR: TBD

**METAL PANELS** 

MP-01 EVENT SPACE FACADE FIELD FABRICATED STANDING SEAM METAL PANEL

FINISH: AMF-02 **GLAZED ALUMINUM FRAMING SYSTEMS - GAFS** 

GAFS-01 PODIUM PUNCHED WINDOW SYSTEM NOTES: 6" FRAME WITH 4-SIDED CAPTURE BASIS OF DESIGN: KAWNEER 1600 WALL SYSTEM

GAFS-02 FITNESS CENTER WINDOW SYSTEM BASIS OF DESIGN: PELLA - ARCHITECT SERIES; CONTEMPORARY FINISH COLOR: TBD GAFS-03 EVENT SPACE CURTAIN WALL SYSTEM

NOTES: 7-1/2" FRAME WITH 4-SIDED CAPTURE BASIS OF DESIGN: KAWNEER 1600 WALL SYSTEM GAFS-04 EVENT SPACE SKYLIGHT SYSTEM

BASIS OF DESIGN: KAWNEER 2000 SKYLIGHT [SSG] FINISH: TBD

ROOF SYSTEMS

FIELD FABRICATED STANDING SEAM METAL ROOF

SINGLE PLY ROOF: PVC; COLOR GRAY TRAFFIC COATING

TAC-01 TRAFFIC COATING LOCATION: FACADES

TAC-02 TRAFFIC COATING LOCATION: BALCONY SOFFITS + FASCIA

COLOR: TBD PC-01 PEDESTRIAN COATING

TONGUE & GROOVE 1" x 6" RANDOM LENGTHS

COLOR: TBD

WOOD - WD WD-01 WOOD SOFFIT SPECIES: CLEAR GRAIN WESTERN RED CEDAR

LOCATION: BALCONIES

WHITE LODGING SERVICES CORPORATION

701 EAST 83RD AVE MERRILLVILLE, IN 46410 ARCHITECT HKS, INC.

350 N SAINT PAUL ST, SUITE 100 DALLAS, TX 75201 INTERIOR DESIGNER

FLICK-MARS

10440 N. CENTRAL EXPY, NO 1210 DALLAS, TX 75231 STRUCTURAL ENGINEERS THORNTON TOMASETTI 8750 NORTH CENTRAL EXPRESSWAY, SUITE 700 DALLAS, TX 75231

MEPF ENGINEERS BLUM CONSULTING ENGINEERS 8144 WALNUT HILL LANE DALLAS, TX 75231

CIVIL ENGINEER PAPE-DAWSON ENGINEERS, INC. 2000 NW LOOP 410 SAN ANTONIO, TX 78213 FOOD SERVICE EQUIPMENT NEXT STEP DESIGN

350 S. NORTHWEST HIGHWAY, SUITE 300 PARK RIDGE, IL 60068 LIGHTING CONSULTANT GRANVILLE MCANEAR LIGHTING DESIGN, LLC

3545 AINSWORTH DROVE **DALLAS, TX 75229** LANDSCAPE TALLEY ASSOCIATES

1925 SAN JACINTO, SUITE 400 DALLAS, TX 75201 TECHNOLOGY CONSULTANT NETWORK TECHNOLOGY, INC

320 SOUTH PERRY STREET LAWRENCEVILLE, GA 30045 VERTICAL TRANSPORTATION

LERCH BATES 2001 BRYAN STREET, SUITE 1930 DALLAS TX, 75201

LIFE SAFETY ENGINEER JENSEN HUGHES 2301 W. PLANO PARKWAY, SUITE 210 PLANO, TX 75075

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**KEY PLAN** 

Date: XX/XX/XXXX

REVISION NO. DESCRIPTION


HKS PROJECT NUMBER 23383.000 10/15/21 50% CONSTRCUTION

DOCUMENTS **EVENT SPACE -**ROOF PLAN AND DETAILS

SHEET NO.

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A15.02

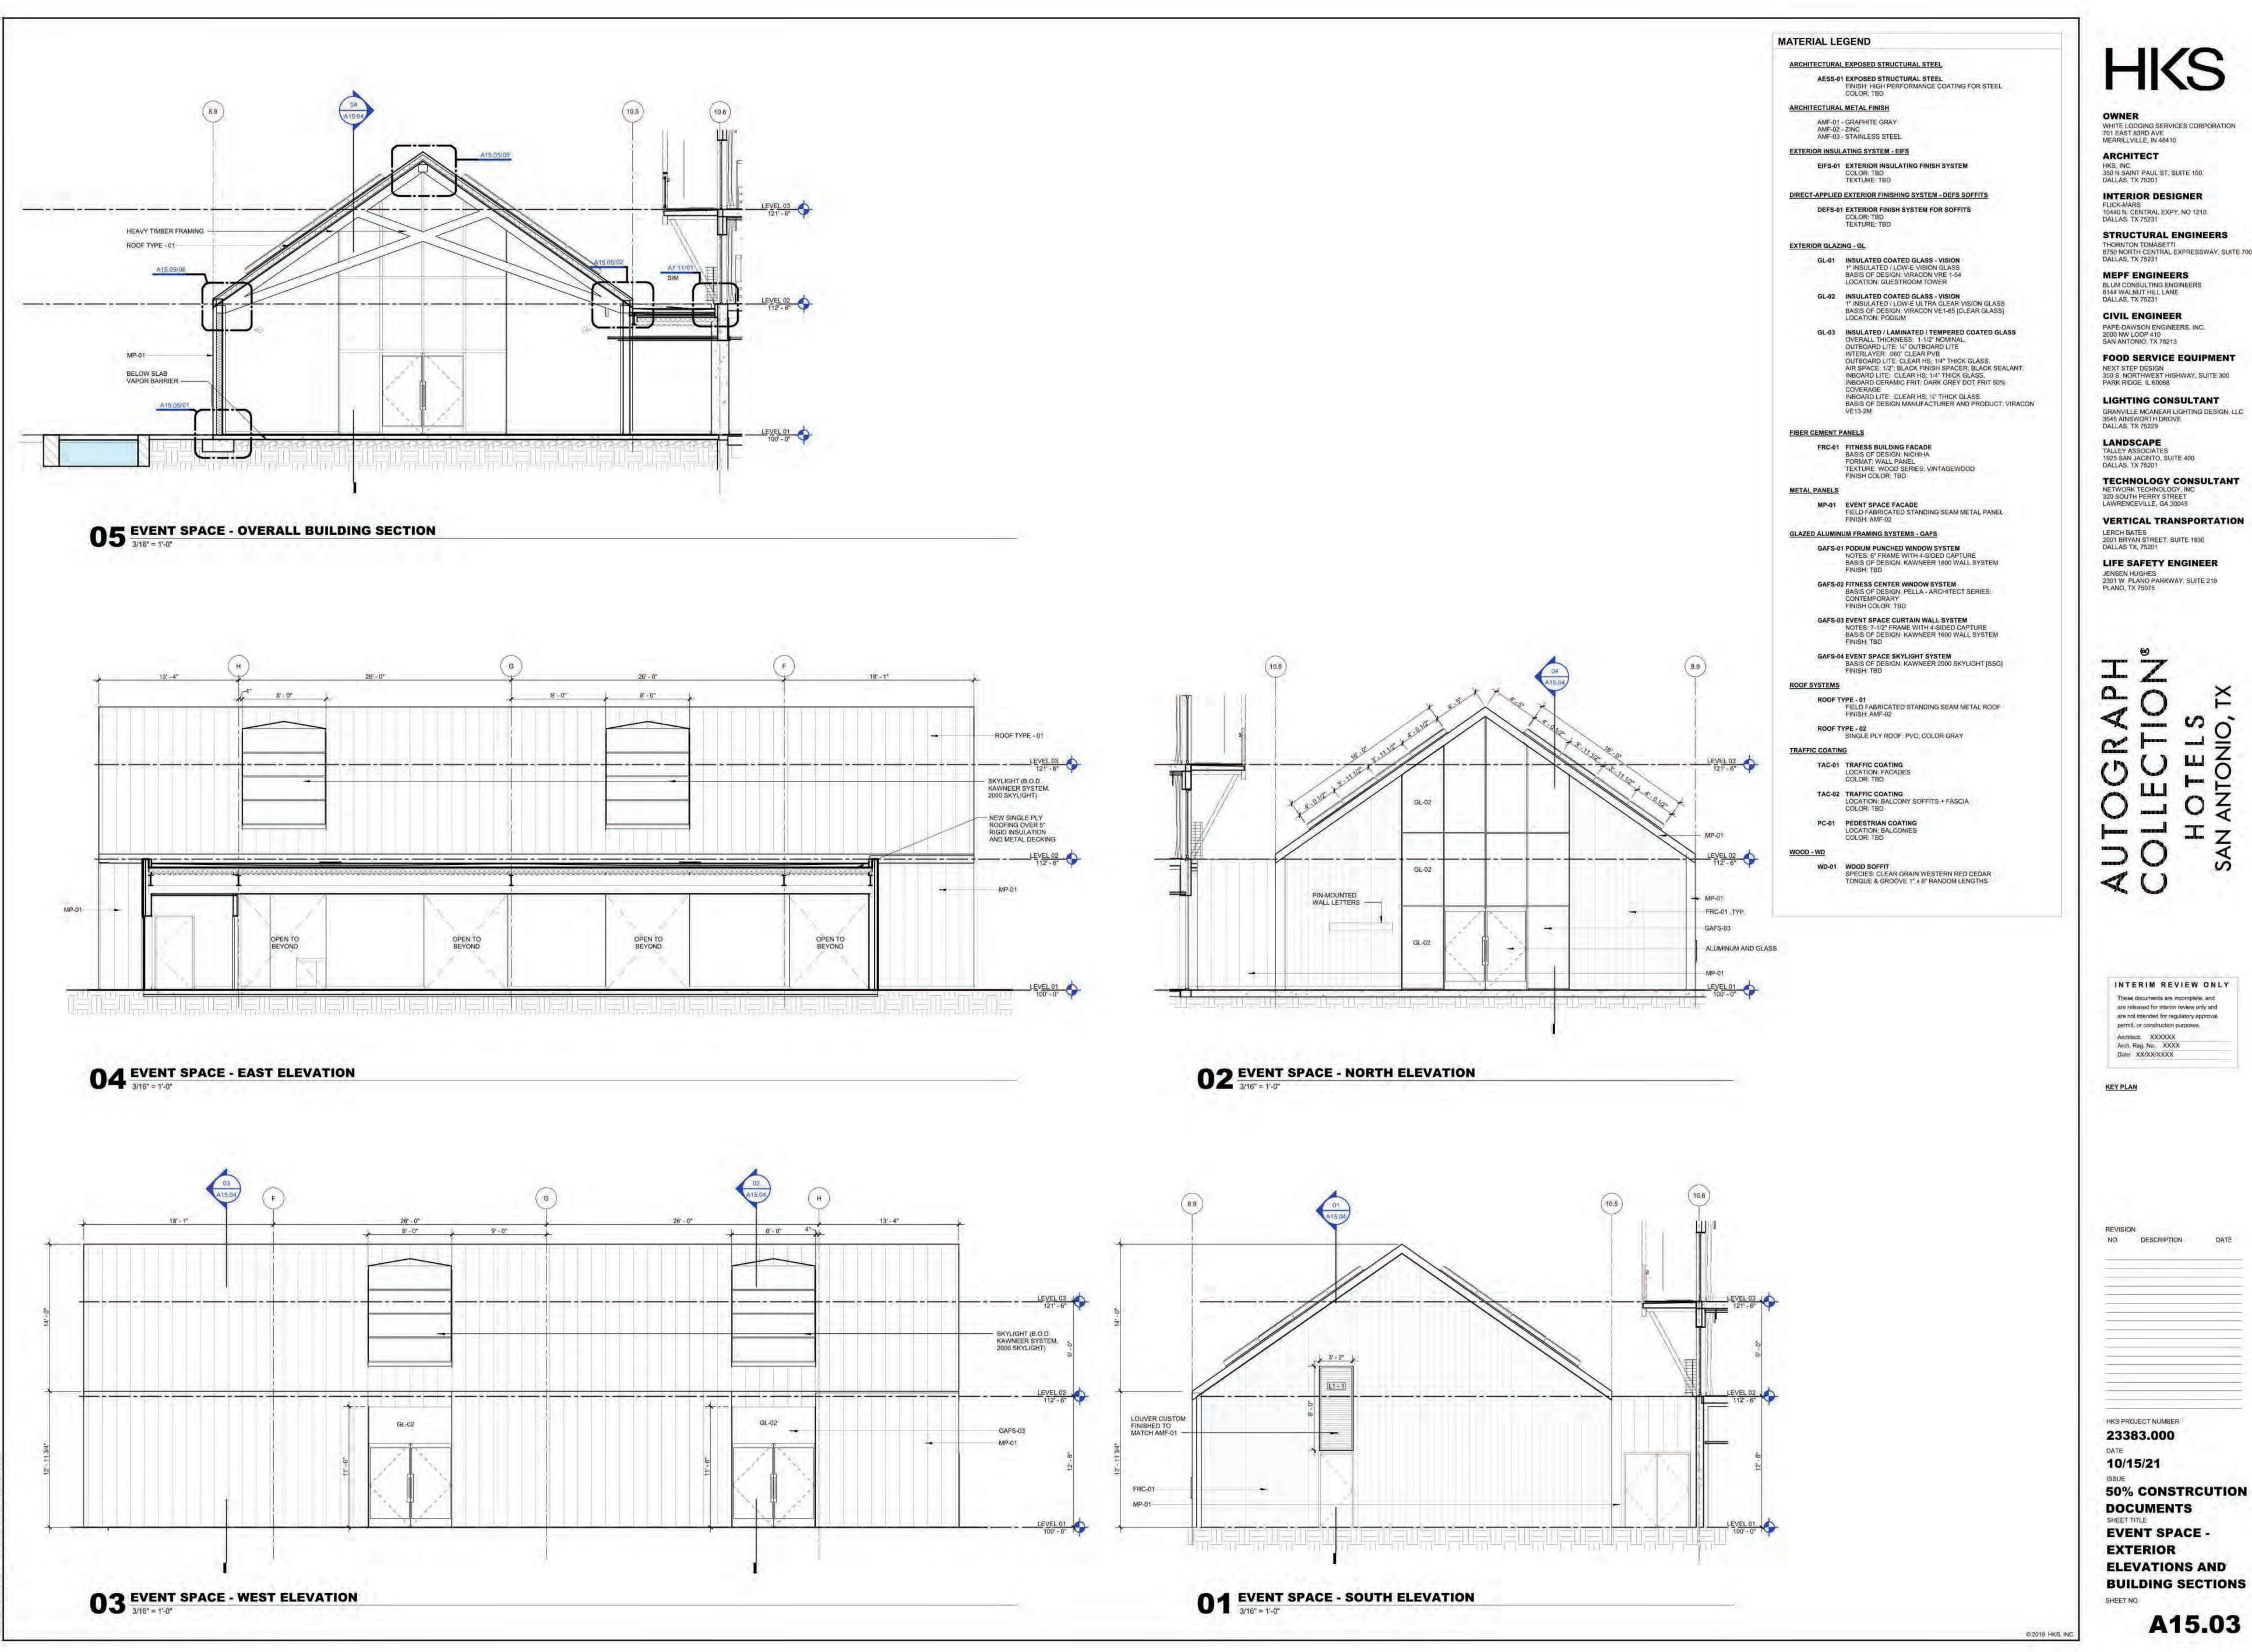

ARCHITECT

350 N SAINT PAUL ST, SUITE 100 DALLAS, TX 75201

INTERIOR DESIGNER

FLICK-MARS 10440 N. CENTRAL EXPY, NO 1210

STRUCTURAL ENGINEERS THORNTON TOMASETTI 8750 NORTH CENTRAL EXPRESSWAY, SUITE 700

MEPF ENGINEERS BLUM CONSULTING ENGINEERS

8144 WALNUT HILL LANE DALLAS, TX 75231

CIVIL ENGINEER

PAPE-DAWSON ENGINEERS, INC. 2000 NW LOOP 410 SAN ANTONIO, TX 78213

FOOD SERVICE EQUIPMENT NEXT STEP DESIGN 350 S. NORTHWEST HIGHWAY, SUITE 300 PARK RIDGE, IL 60068

LIGHTING CONSULTANT GRANVILLE MCANEAR LIGHTING DESIGN, LLC 3545 AINSWORTH DROVE

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REVISION

HKS PROJECT NUMBER


23383.000

10/15/21

DOCUMENTS **EVENT SPACE -**EXTERIOR **ELEVATIONS AND** 

**BUILDING SECTIONS** 

A15.03

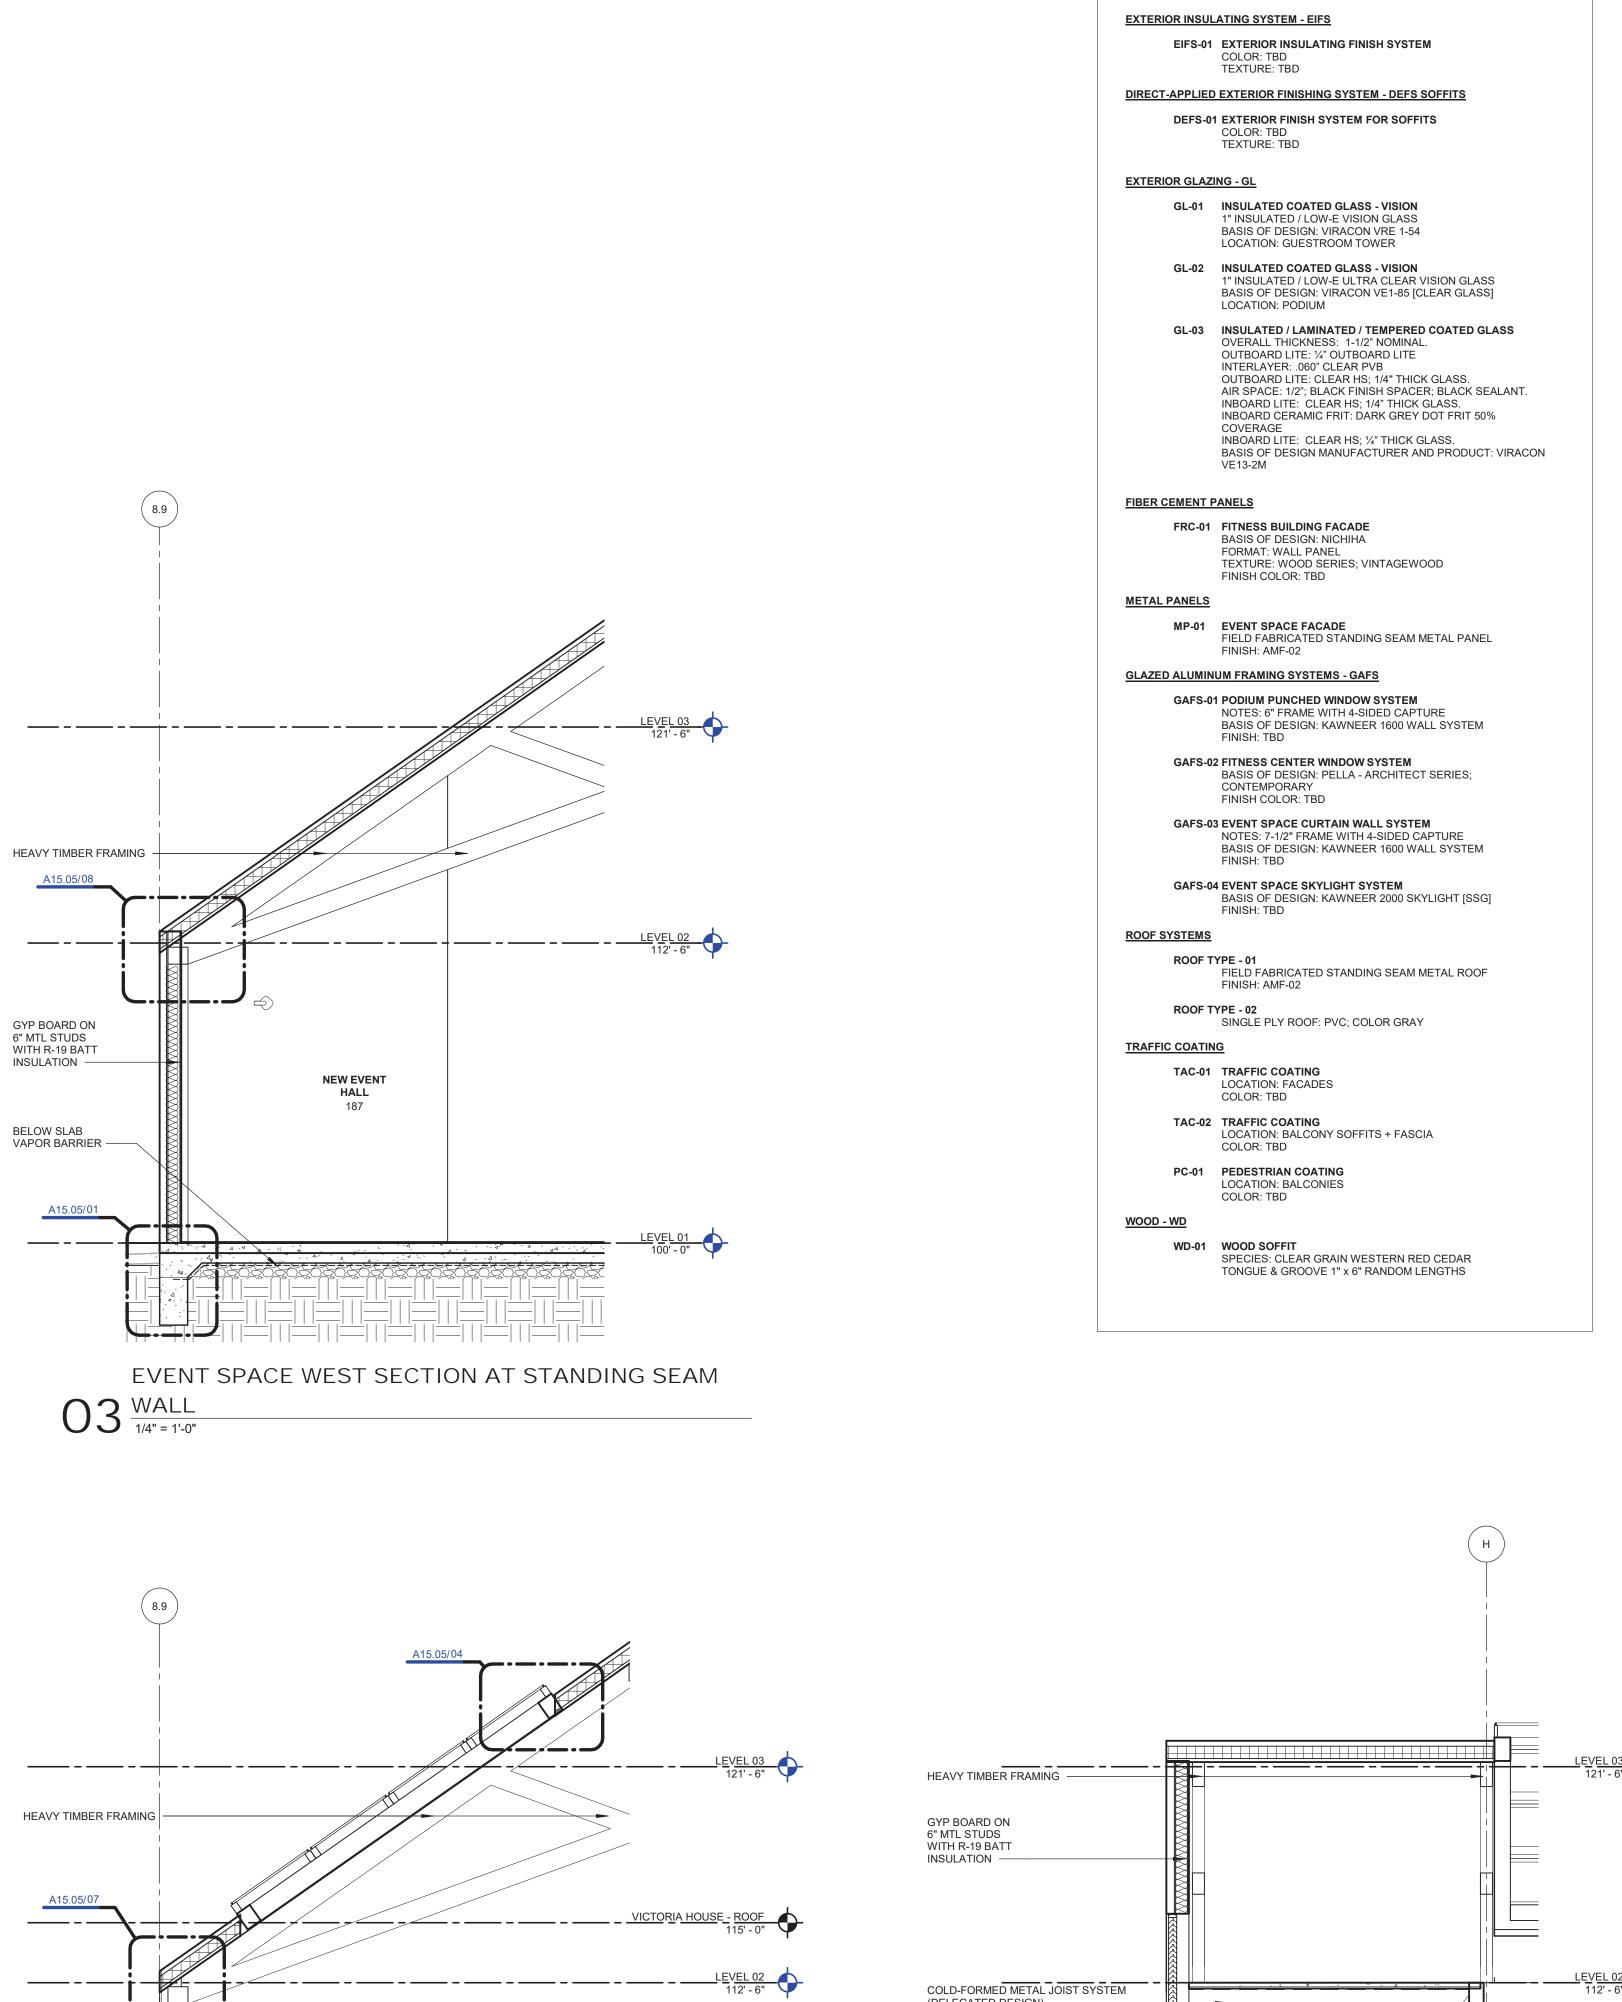

**NEW EVENT** 

BELOW SLAB VAPOR BARRIER —

\_\_\_\_\_

\_\_\_\_\_ = \_\_\_\_ <u>LEVEL 02</u>

 $04^{\frac{\text{EVENT SPACE NORTH SECTION AT CURTAINWALL}}{1/4" = 1'-0"}}$ 

**NEW EVENT** 

**HALL** 187

FRC-01 ALONG ENTIRE UNDER SIDE


OF BROW ----

BELOW SLAB VAPOR BARRIER —

AESS-01 EXPOSED STRUCTURAL STEEL FINISH: HIGH PERFORMANCE COATING FOR STEEL COLOR: TBD ARCHITECTURAL METAL FINISH AMF-01 - GRAPHITE GRAY AMF-02 - ZINC AMF-03 - STAINLESS STEEL

MATERIAL LEGEND

ARCHITECTURAL EXPOSED STRUCTURAL STEEL

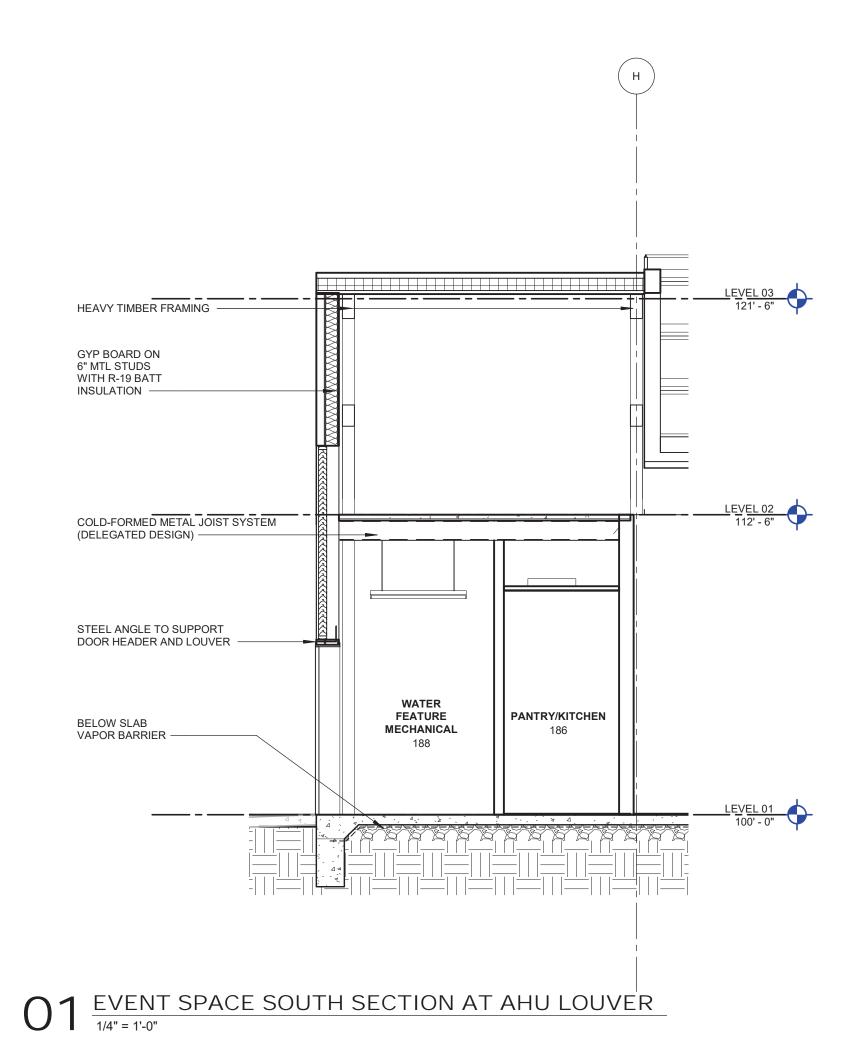

WHITE LODGING SERVICES CORPORATION 701 EAST 83RD AVE

MERRILLVILLE, IN 46410 ARCHITECT HKS, INC.

350 N SAINT PAUL ST, SUITE 100 DALLAS, TX 75201

INTERIOR DESIGNER FLICK-MARS 10440 N. CENTRAL EXPY, NO 1210 DALLAS, TX 75231 STRUCTURAL ENGINEERS

8750 NORTH CENTRAL EXPRESSWAY, SUITE 700 DALLAS, TX 75231 MEPF ENGINEERS BLUM CONSULTING ENGINEERS

THORNTON TOMASETTI

8144 WALNUT HILL LANE DALLAS, TX 75231 CIVIL ENGINEER PAPE-DAWSON ENGINEERS, INC. 2000 NW LOOP 410 SAN ANTONIO, TX 78213

FOOD SERVICE EQUIPMENT NEXT STEP DESIGN 350 S. NORTHWEST HIGHWAY, SUITE 300 PARK RIDGE, IL 60068

> LIGHTING CONSULTANT GRANVILLE MCANEAR LIGHTING DESIGN, LLC 3545 AINSWORTH DROVE DALLAS, TX 75229

LANDSCAPE TALLEY ASSOCIATES

1925 SAN JACINTO, SUITE 400 DALLAS, TX 75201 TECHNOLOGY CONSULTANT NETWORK TECHNOLOGY, INC

320 SOUTH PERRY STREET LAWRENCEVILLE, GA 30045 VERTICAL TRANSPORTATION LERCH BATES 2001 BRYAN STREET, SUITE 1930

DALLAS TX, 75201 LIFE SAFETY ENGINEER JENSEN HUGHES 2301 W. PLANO PARKWAY, SUITE 210 PLANO, TX 75075

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**KEY PLAN** 

REVISION

DESCRIPTION


HKS PROJECT NUMBER 23383.000

10/15/21 50% CONSTRCUTION

DOCUMENTS **EVENT SPACE -**WALL SECTIONS

SHEET NO. A15.04

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ARCHITECT HKS, INC. 350 N SAINT PAUL ST, SUITE 100 DALLAS, TX 75201

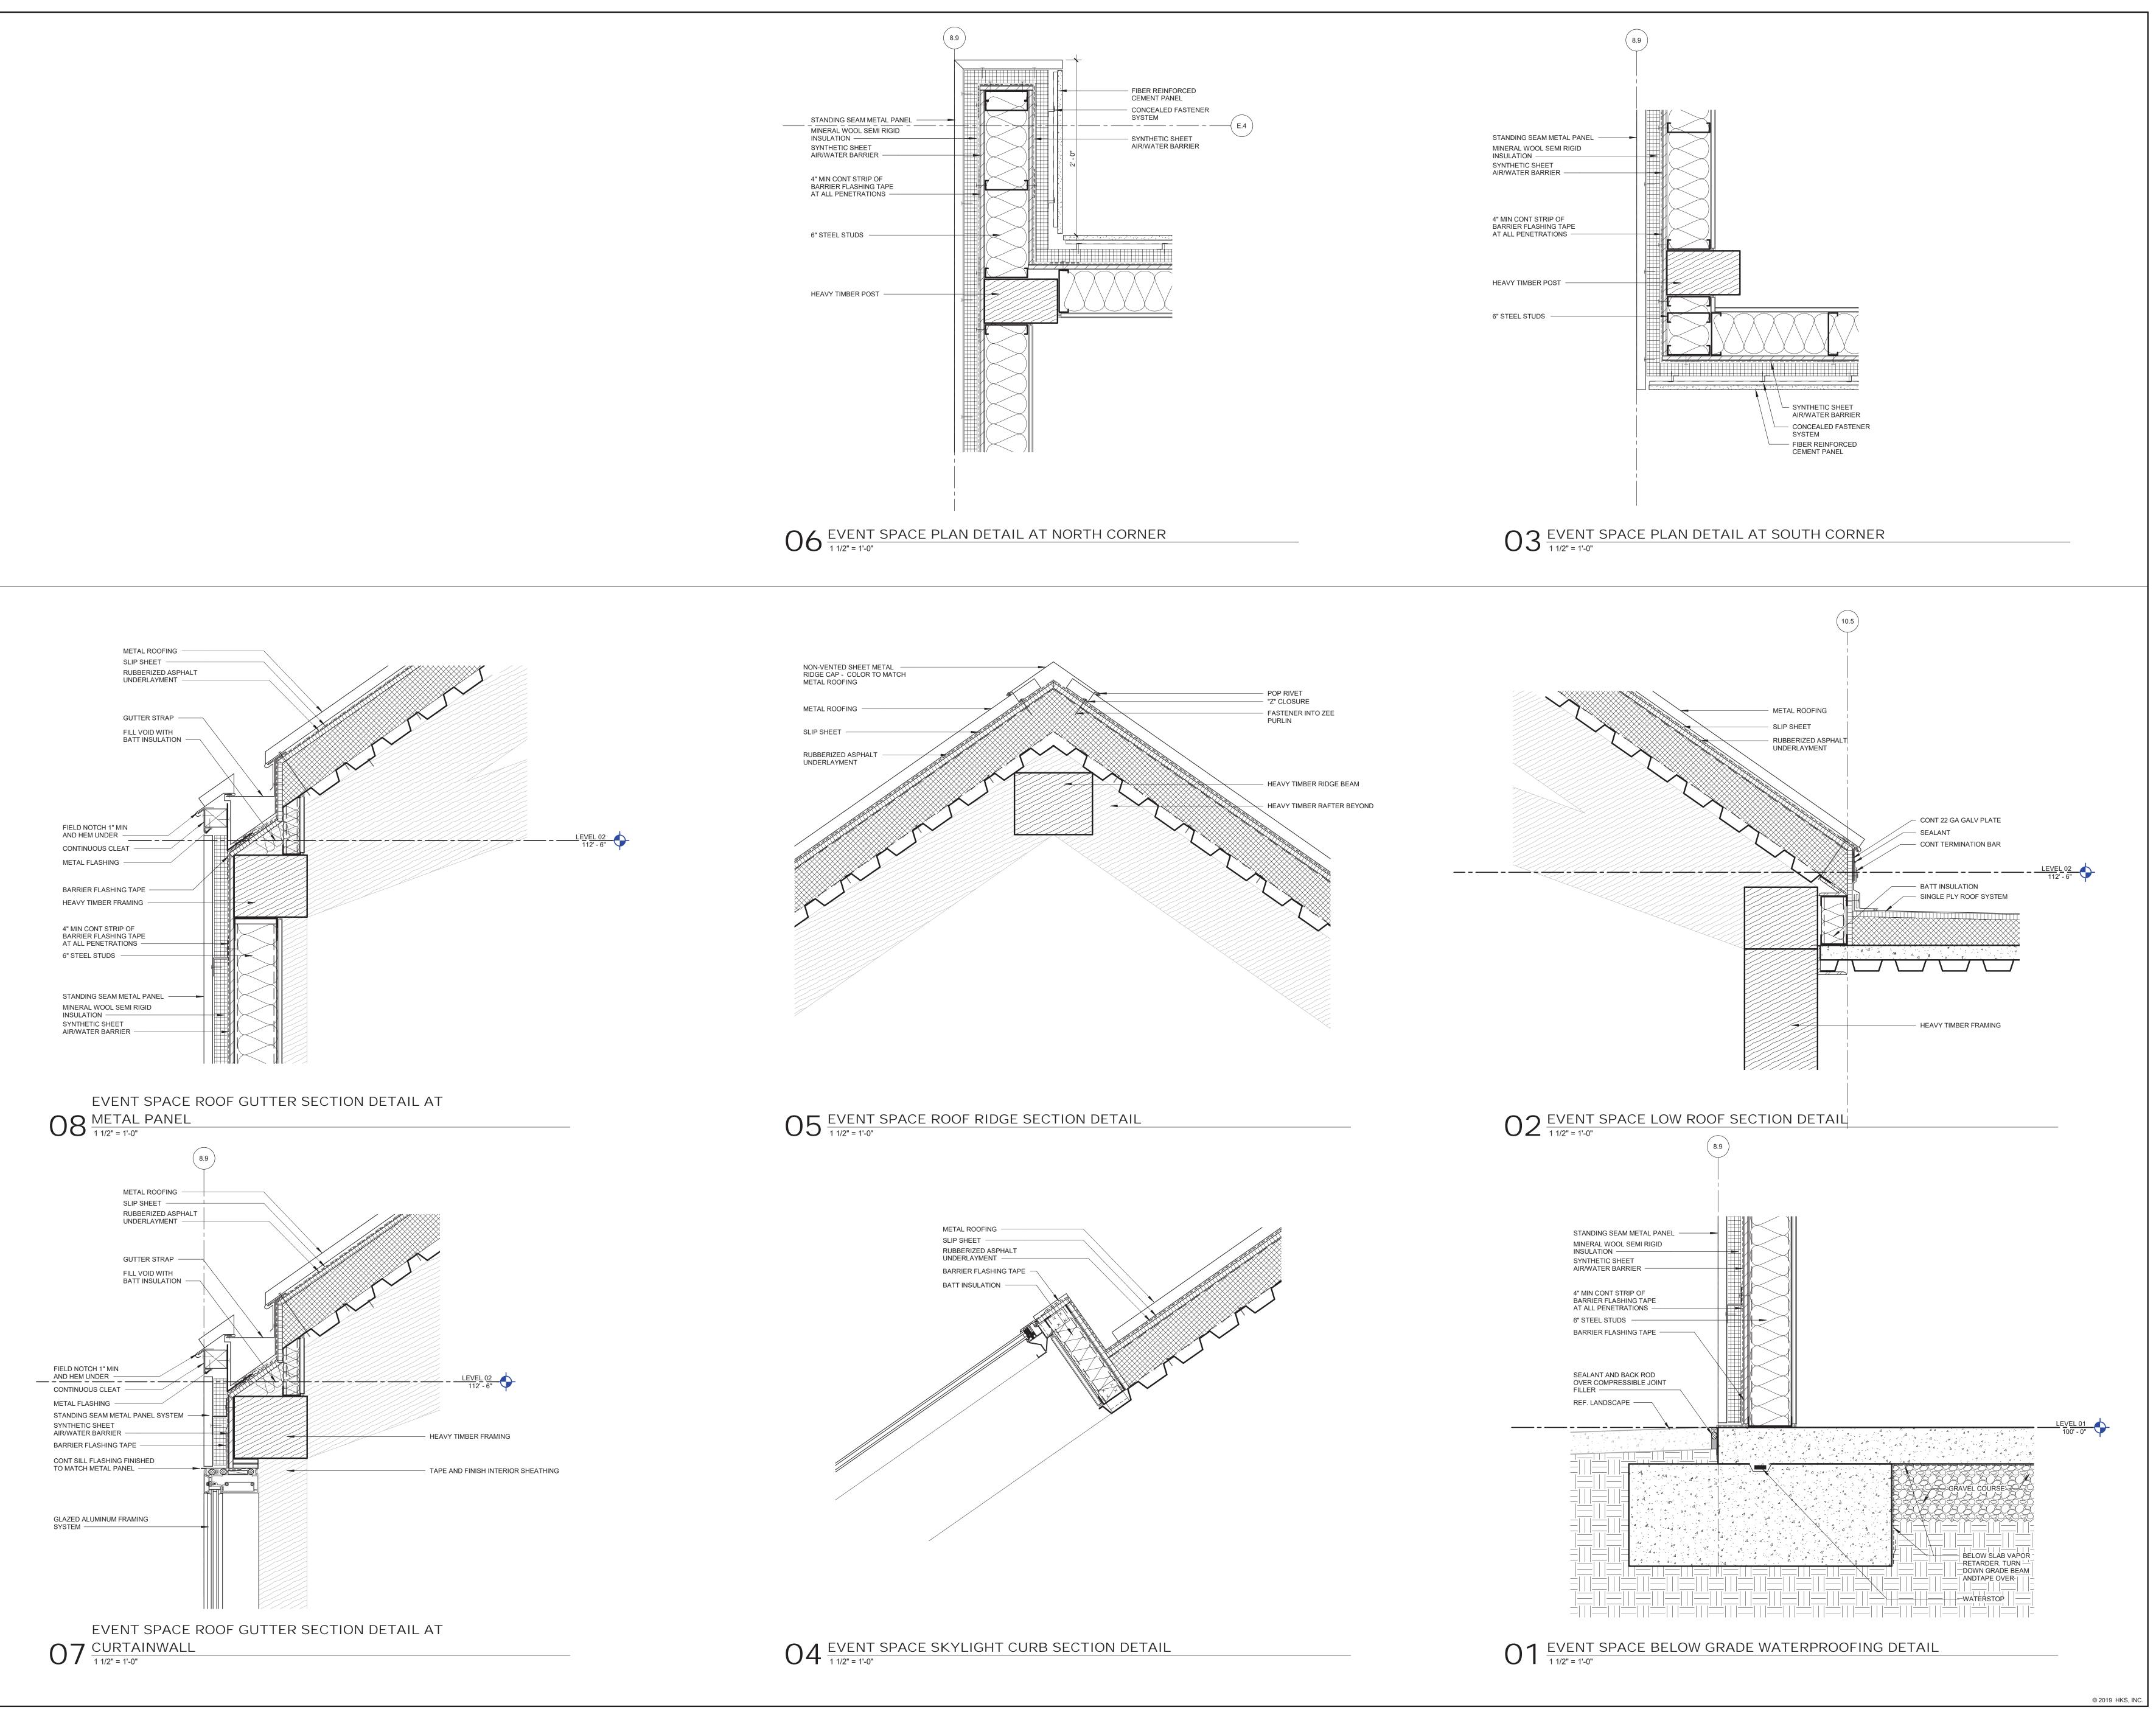INTERIOR DESIGNER FLICK-MARS 10440 N. CENTRAL EXPY, NO 1210 DALLAS, TX 75231

STRUCTURAL ENGINEERS THORNTON TOMASETTI 8750 NORTH CENTRAL EXPRESSWAY, SUITE 700 DALLAS, TX 75231

MEPF ENGINEERS BLUM CONSULTING ENGINEERS 8144 WALNUT HILL LANE DALLAS, TX 75231

CIVIL ENGINEER PAPE-DAWSON ENGINEERS, INC. 2000 NW LOOP 410

SAN ANTONIO, TX 78213 FOOD SERVICE EQUIPMENT NEXT STEP DESIGN 350 S. NORTHWEST HIGHWAY, SUITE 300

PARK RIDGE, IL 60068 LIGHTING CONSULTANT GRANVILLE MCANEAR LIGHTING DESIGN, LLC 3545 AINSWORTH DROVE

DALLAS, TX 75229 LANDSCAPE TALLEY ASSOCIATES

1925 SAN JACINTO, SUITE 400 DALLAS, TX 75201

TECHNOLOGY CONSULTANT NETWORK TECHNOLOGY, INC 320 SOUTH PERRY STREET LAWRENCEVILLE, GA 30045

VERTICAL TRANSPORTATION LERCH BATES 2001 BRYAN STREET, SUITE 1930

DALLAS TX, 75201 LIFE SAFETY ENGINEER JENSEN HUGHES 2301 W. PLANO PARKWAY, SUITE 210

PLANO, TX 75075

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**KEY PLAN** 


HKS PROJECT NUMBER 23383.000 DATE

10/15/21 50% CONSTRCUTION


DOCUMENTS **EVENT SPACE -**DETAILS

SHEET NO.


A15.05

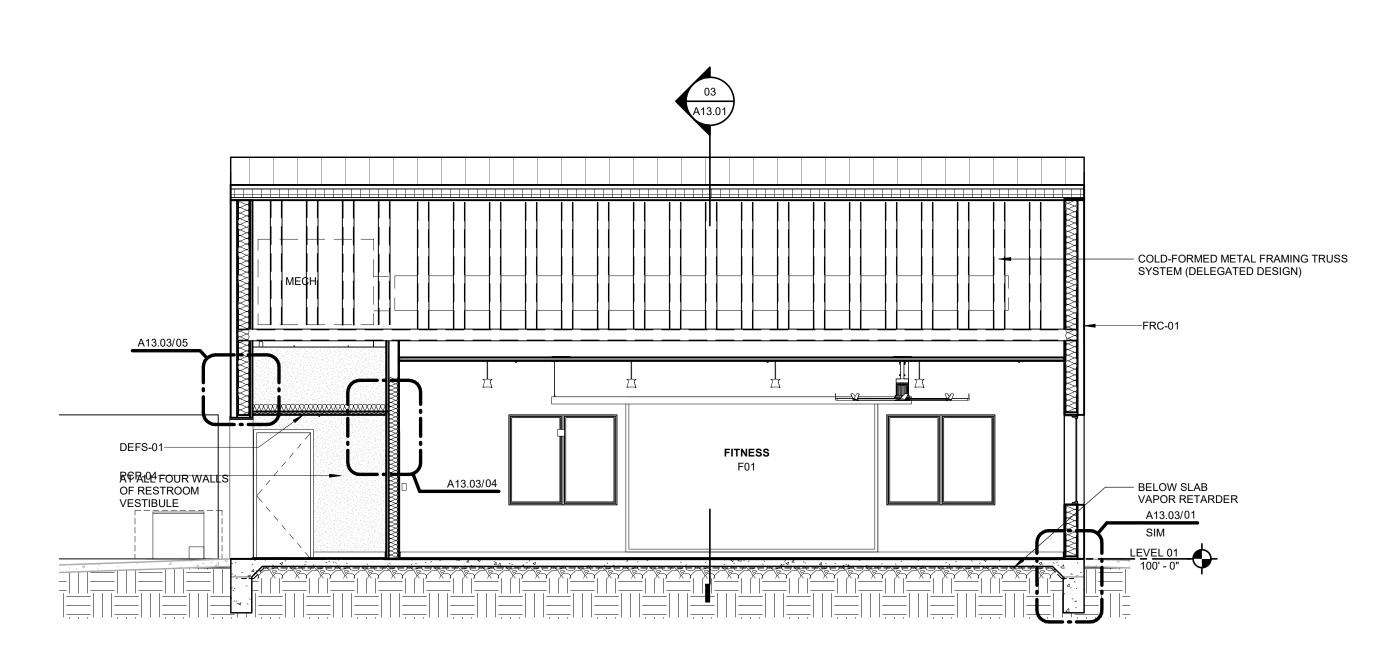

 $06 \frac{\text{FITNESS CENTER - OVERALL E/W BUILDING SECTION}}{3/16" = 1'-0"}$ 

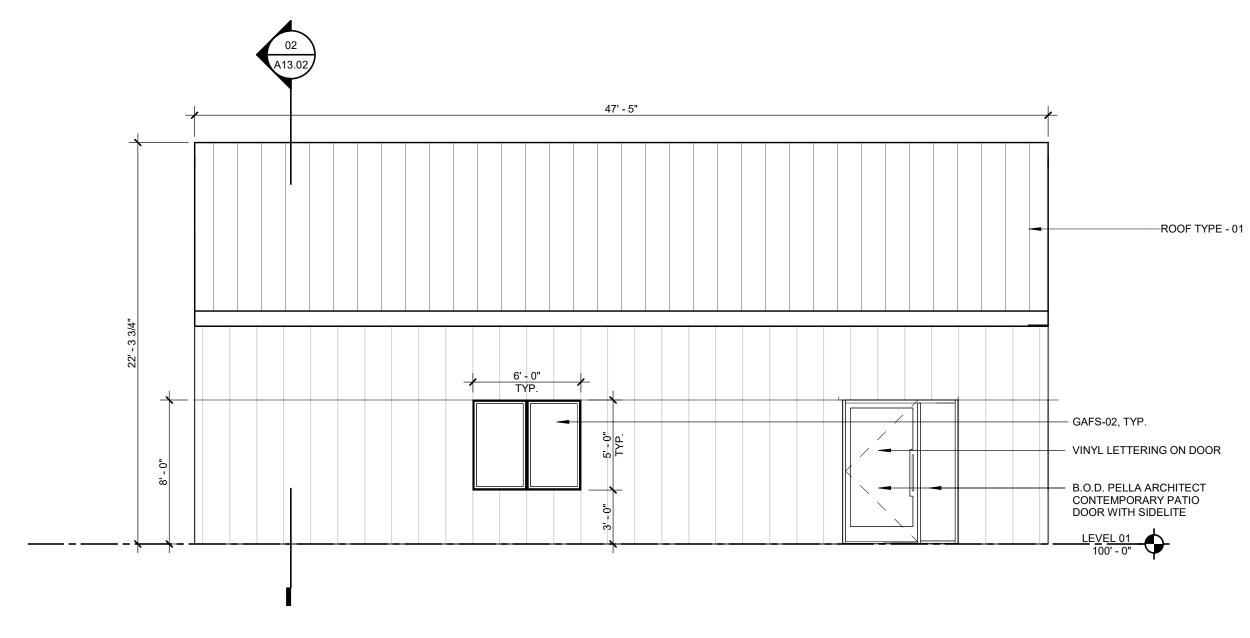


 $05_{\frac{3}{16"}=1'-0"}$ 

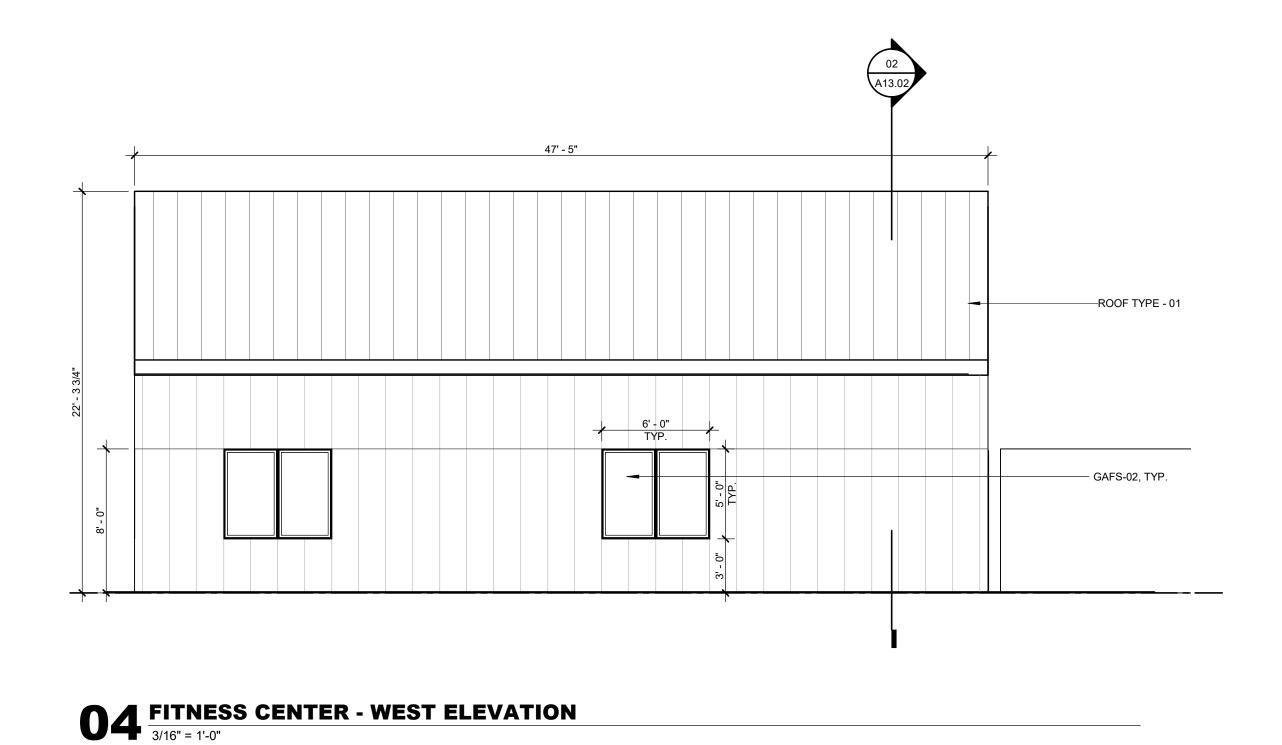


A13.03/06 - COLD-FORMED METAL FRAMING TRUSS SYSTEM (DELEGATED DESIGN)

03 FITNESS CENTER - OVERALL N/S BUILDING SECTION

3/16" = 1'-0"

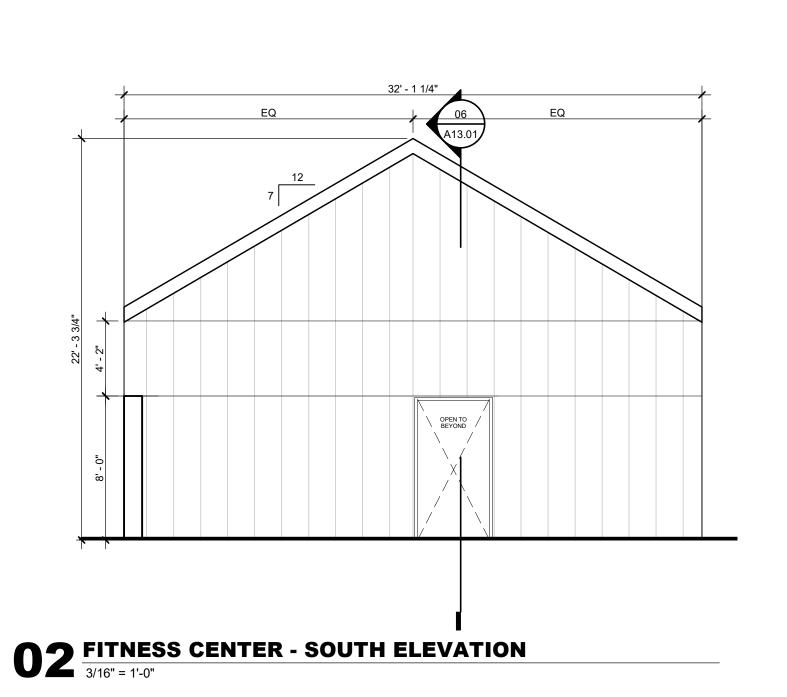

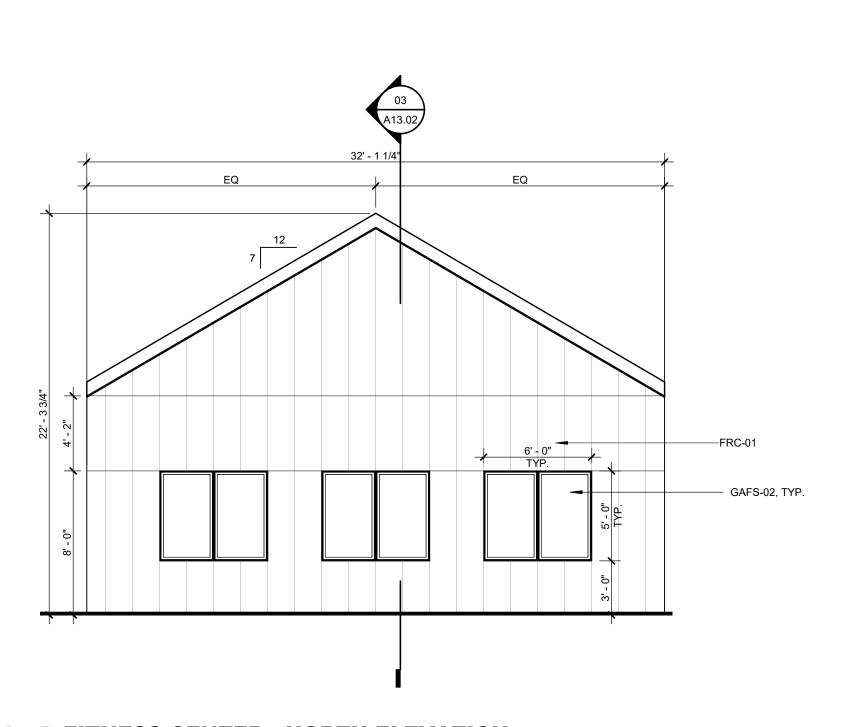

 $01 \frac{\text{FITNESS CENTER - NORTH ELEVATION}}{3/16" = 1'-0"}$ 

MATERIAL LEGEND

ARCHITECTURAL EXPOSED STRUCTURAL STEEL AESS-01 EXPOSED STRUCTURAL STEEL

FINISH: HIGH PERFORMANCE COATING FOR STEEL COLOR: TBD

ARCHITECTURAL METAL FINISH AMF-01 - GRAPHITE GRAY

AMF-02 - ZINC AMF-03 - STAINLESS STEEL

**EXTERIOR INSULATING SYSTEM - EIFS** EIFS-01 EXTERIOR INSULATING FINISH SYSTEM

COLOR: TBD TEXTURE: TBD DIRECT-APPLIED EXTERIOR FINISHING SYSTEM - DEFS SOFFITS

DEFS-01 EXTERIOR FINISH SYSTEM FOR SOFFITS COLOR: TBD TEXTURE: TBD

**EXTERIOR GLAZING - GL** 

GL-01 INSULATED COATED GLASS - VISION 1" INSULATED / LOW-E VISION GLASS BASIS OF DESIGN: VIRACON VRE 1-54 LOCATION: GUESTROOM TOWER

GL-02 INSULATED COATED GLASS - VISION 1" INSULATED / LOW-E ULTRA CLEAR VISION GLASS BASIS OF DESIGN: VIRACON VE1-85 [CLEAR GLASS]

LOCATION: PODIUM GL-03 INSULATED / LAMINATED / TEMPERED COATED GLASS OVERALL THICKNESS: 1-1/2" NOMINAL. OUTBOARD LITE: 1/4" OUTBOARD LITE INTERLAYER: .060" CLEAR PVB OUTBOARD LITE: CLEAR HS; 1/4" THICK GLASS. AIR SPACE: 1/2"; BLACK FINISH SPACER; BLACK SEALANT. INBOARD LITE: CLEAR HS; 1/4" THICK GLASS. INBOARD CERAMIC FRIT: DARK GREY DOT FRIT 50% COVERAGE INBOARD LITE: CLEAR HS; 1/4" THICK GLASS.

BASIS OF DESIGN MANUFACTURER AND PRODUCT: VIRACON

FIBER CEMENT PANELS

FRC-01 FITNESS BUILDING FACADE BASIS OF DESIGN: NICHIHA FORMAT: WALL PANEL TEXTURE: WOOD SERIES; VINTAGEWOOD

FINISH COLOR: TBD

METAL PANELS

MP-01 EVENT SPACE FACADE FIELD FABRICATED STANDING SEAM METAL PANEL

**GLAZED ALUMINUM FRAMING SYSTEMS - GAFS** 

GAFS-01 PODIUM PUNCHED WINDOW SYSTEM NOTES: 6" FRAME WITH 4-SIDED CAPTURE

BASIS OF DESIGN: KAWNEER 1600 WALL SYSTEM FINISH: TBD GAFS-02 FITNESS CENTER WINDOW SYSTEM

BASIS OF DESIGN: PELLA - ARCHITECT SERIES; CONTEMPORARY FINISH COLOR: TBD GAFS-03 EVENT SPACE CURTAIN WALL SYSTEM
NOTES: 7-1/2" FRAME WITH 4-SIDED CAPTURE

BASIS OF DESIGN: KAWNEER 1600 WALL SYSTEM GAFS-04 EVENT SPACE SKYLIGHT SYSTEM

BASIS OF DESIGN: KAWNEER 2000 SKYLIGHT [SSG]

PCP-01 FITNESS EXTERIOR WALLS BASIS OF DESIGN: TBD

PORTLAND CEMENT PLASTER

FINISH: TBD **ROOF SYSTEMS** 

> ROOF TYPE - 01
> FIELD FABRICATED STANDING SEAM METAL ROOF FINISH: AMF-02

**ROOF TYPE - 02** SINGLE PLY ROOF: PVC; COLOR GRAY

TRAFFIC COATING

TAC-01 TRAFFIC COATING LOCATION: FACADES

COLOR: TBD TAC-02 TRAFFIC COATING LOCATION: BALCONY SOFFITS + FASCIA

COLOR: TBD PC-01 PEDESTRIAN COATING

LOCATION: BALCONIES COLOR: TBD

WOOD - WD

WD-01 WOOD SOFFIT SPECIES: CLEAR GRAIN WESTERN RED CEDAR TONGUE & GROOVE 1" x 6" RANDOM LENGTHS

**LIFE SAFETY ENGINEER** JENSEN HUGHES 2301 W. PLANO PARKWAY, SUITE 210 PLANO, TX 75075

WHITE LODGING SERVICES CORPORATION

701 EAST 83RD AVE MERRILLVILLE, IN 46410

**ARCHITECT** 

DALLAS, TX 75201

DALLAS, TX 75231

DALLAS, TX 75231

THORNTON TOMASETTI

MEPF ENGINEERS BLUM CONSULTING ENGINEERS

8144 WALNUT HILL LANE DALLAS, TX 75231

**CIVIL ENGINEER** 

SAN ANTONIO, TX 78213

2000 NW LOOP 410

NEXT STEP DESIGN

PARK RIDGE, IL 60068

3545 AINSWORTH DROVE

1925 SAN JACINTO, SUITE 400

NETWORK TECHNOLOGY, INC

320 SOUTH PERRY STREET

LAWRENCEVILLE, GA 30045

2001 BRYAN STREET, SUITE 1930

DALLAS, TX 75229

LANDSCAPE

DALLAS, TX 75201

LERCH BATES

DALLAS TX, 75201

TALLEY ASSOCIATES

PAPE-DAWSON ENGINEERS, INC.

**FOOD SERVICE EQUIPMENT** 

350 S. NORTHWEST HIGHWAY, SUITE 300

GRANVILLE MCANEAR LIGHTING DESIGN, LLC

**TECHNOLOGY CONSULTANT** 

**VERTICAL TRANSPORTATION** 

LIGHTING CONSULTANT

FLICK-MARS

350 N SAINT PAUL ST, SUITE 100

INTERIOR DESIGNER

10440 N. CENTRAL EXPY, NO 1210

STRUCTURAL ENGINEERS

8750 NORTH CENTRAL EXPRESSWAY, SUITE 700

HKS. INC.

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**KEY PLAN** 

REVISION NO.	DESCRIPTION	DATE

HKS PROJECT NUMBER 23383.000


10/15/21 **50% CONSTRCUTION DOCUMENTS FITNESS CENTER -**

**EXTERIOR ELEVATIONS AND BUILDING SECTIONS** 


SHEET NO.

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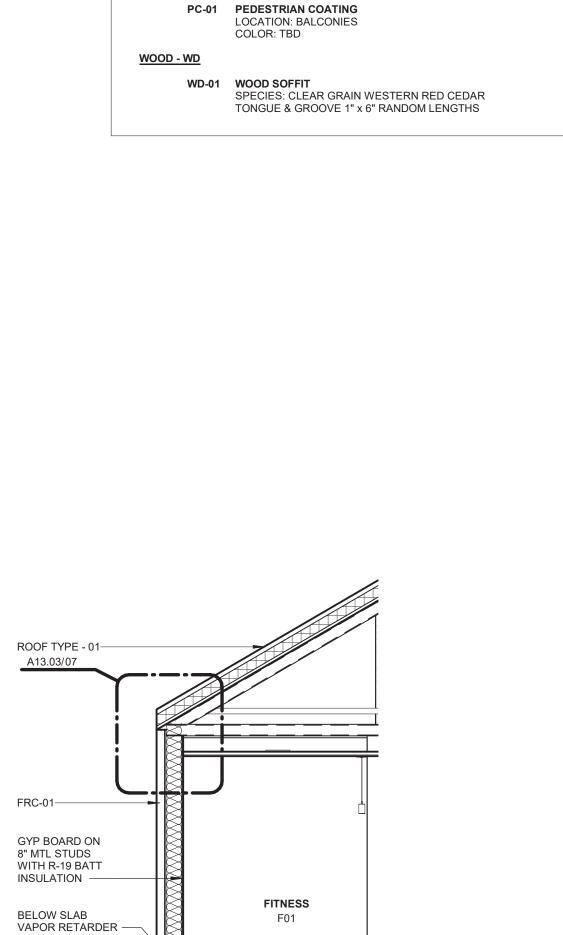
A13.01

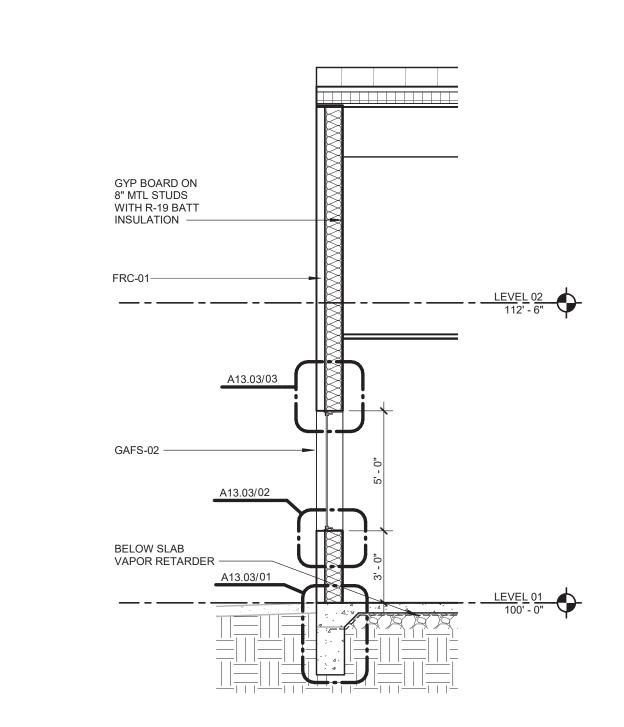

FITNESS CENTER WEST SECTION AT PUNCHED  $03\frac{\text{WINDOWS}}{1/4" = 1'-0"}$ 

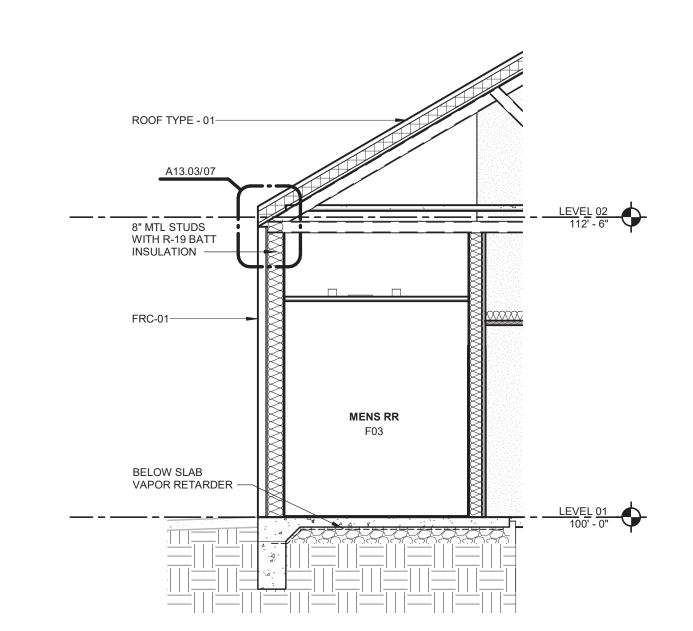

FITNESS CENTER NORTH SECTION AT RESTROOM  $02^{\frac{\text{VESTIBULE}}{1/4" = 1'-0"}}$ 



 $O_{1/4"=1'-0"}$  FITNESS CENTER NORTH SECTION

## MATERIAL LEGEND ARCHITECTURAL EXPOSED STRUCTURAL STEEL **AESS-01 EXPOSED STRUCTURAL STEEL** FINISH: HIGH PERFORMANCE COATING FOR STEEL COLOR: TBD ARCHITECTURAL METAL FINISH AMF-01 - GRAPHITE GRAY AMF-02 - ZINC AMF-03 - STAINLESS STEEL **EXTERIOR INSULATING SYSTEM - EIFS** EIFS-01 EXTERIOR INSULATING FINISH SYSTEM COLOR: TBD TEXTURE: TBD **DIRECT-APPLIED EXTERIOR FINISHING SYSTEM - DEFS SOFFITS DEFS-01 EXTERIOR FINISH SYSTEM FOR SOFFITS** TEXTURE: TBD **EXTERIOR GLAZING - GL** GL-01 INSULATED COATED GLASS - VISION 1" INSULATED / LOW-E VISION GLASS BASIS OF DESIGN: VIRACON VRE 1-54 LOCATION: GUESTROOM TOWER GL-02 INSULATED COATED GLASS - VISION 1" INSULATED / LOW-E ULTRA CLEAR VISION GLASS BASIS OF DESIGN: VIRACON VE1-85 [CLEAR GLASS] LOCATION: PODIUM GL-03 INSULATED / LAMINATED / TEMPERED COATED GLASS OVERALL THICKNESS: 1-1/2" NOMINAL. INTERLAYER: .060" CLEAR PVB OUTBOARD LITE: CLEAR HS; 1/4" THICK GLASS. AIR SPACE: 1/2"; BLACK FINISH SPACER; BLACK SEALANT. INBOARD LITE: CLEAR HS; 1/4" THICK GLASS. INBOARD CERAMIC FRIT: DARK GREY DOT FRIT 50% INBOARD LITE: CLEAR HS; 1/4" THICK GLASS. BASIS OF DESIGN MANUFACTURER AND PRODUCT: VIRACON FIBER CEMENT PANELS FRC-01 FITNESS BUILDING FACADE BASIS OF DESIGN: NICHIHA FORMAT: WALL PANEL TEXTURE: WOOD SERIES; VINTAGEWOOD FINISH COLOR: TBD METAL PANELS MP-01 EVENT SPACE FACADE FIELD FABRICATED STANDING SEAM METAL PANEL **GLAZED ALUMINUM FRAMING SYSTEMS - GAFS** GAFS-01 PODIUM PUNCHED WINDOW SYSTEM NOTES: 6" FRAME WITH 4-SIDED CAPTURE BASIS OF DESIGN: KAWNEER 1600 WALL SYSTEM

BASIS OF DESIGN: KAWNEER 1600 WALL SYSTEM FINISH: TBD GAFS-04 EVENT SPACE SKYLIGHT SYSTEM BASIS OF DESIGN: KAWNEER 2000 SKYLIGHT [SSG] PORTLAND CEMENT PLASTER PCP-01 FITNESS EXTERIOR WALLS BASIS OF DESIGN: TBD FINISH: TBD

GAFS-02 FITNESS CENTER WINDOW SYSTEM

GAFS-03 EVENT SPACE CURTAIN WALL SYSTEM

FINISH COLOR: TBD

BASIS OF DESIGN: PELLA - ARCHITECT SERIES;

NOTES: 7-1/2" FRAME WITH 4-SIDED CAPTURE

FINISH: TBD

## ROOF SYSTEMS

ROOF TYPE - 01
FIELD FABRICATED STANDING SEAM METAL ROOF FINISH: AMF-02

SINGLE PLY ROOF: PVC; COLOR GRAY

## TRAFFIC COATING

TAC-01 TRAFFIC COATING LOCATION: FACADES

TAC-02 TRAFFIC COATING LOCATION: BALCONY SOFFITS + FASCIA COLOR: TBD

WHITE LODGING SERVICES CORPORATION

701 EAST 83RD AVE MERRILLVILLE, IN 46410

ARCHITECT

DALLAS, TX 75201

350 N SAINT PAUL ST, SUITE 100

INTERIOR DESIGNER

10440 N. CENTRAL EXPY, NO 1210

STRUCTURAL ENGINEERS

8750 NORTH CENTRAL EXPRESSWAY, SUITE 700

HKS, INC.

FLICK-MARS

DALLAS, TX 75231

DALLAS, TX 75231

THORNTON TOMASETTI

MEPF ENGINEERS

8144 WALNUT HILL LANE DALLAS, TX 75231

CIVIL ENGINEER

2000 NW LOOP 410 SAN ANTONIO, TX 78213

NEXT STEP DESIGN

PARK RIDGE, IL 60068

3545 AINSWORTH DROVE DALLAS, TX 75229

LANDSCAPE

DALLAS, TX 75201

LERCH BATES

DALLAS TX, 75201

JENSEN HUGHES

PLANO, TX 75075

TALLEY ASSOCIATES

1925 SAN JACINTO, SUITE 400

NETWORK TECHNOLOGY, INC 320 SOUTH PERRY STREET

2001 BRYAN STREET, SUITE 1930

LIFE SAFETY ENGINEER

2301 W. PLANO PARKWAY, SUITE 210

LAWRENCEVILLE, GA 30045

BLUM CONSULTING ENGINEERS

PAPE-DAWSON ENGINEERS, INC.

FOOD SERVICE EQUIPMENT

350 S. NORTHWEST HIGHWAY, SUITE 300

LIGHTING CONSULTANT

GRANVILLE MCANEAR LIGHTING DESIGN, LLC

TECHNOLOGY CONSULTANT

VERTICAL TRANSPORTATION

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**KEY PLAN** 

REVISION	DESCRIPTION	DATI
NO.	DESCRIPTION	DATI

23383.000 DATE 10/15/21 50% CONSTRCUTION DOCUMENTS FITNESS CENTER -WALL SECTIONS

SHEET NO.

A13.02

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 $O4^{\frac{\text{HEADER DETAIL}}{1 \cdot 1/2" = 1'-0"}}$ 

BASE COAT, REINFORCING

BARRIER FLASHING TAPE

PORTLAND CEMENT PLASTER SYSTEM -

NOTE:
REFER TO PORTLAND CEMENT PLASTER
SYSTEM DETAIL FOR TYPICAL PORTLAND
CEMENT PLASTER SYSTEM COMPONENTS.

DEFS CASING BEAD PLASTER CASING BEAD

BUILDING PAPER -

SYNTHETIC SHEET AIR/WATER BARRIER -

GYPSUM SHEATHING -

R-19 BATT INSULATION -

8" STEEL STUDS -


FITNESS CENTER DEFS SOFFIT AND CEMENT PLASTER

FITNESS CENTER PERIMETER FOUNDATION BELOW O1 GRADE SYSTEM AT GRADE BEAM  $\frac{11/2" = 1'-0"}{1}$ 


SLIP SHEET -RUBBERIZED ASPHALT UNDERLAYMENT -GUTTER STRAP -FIELD NOTCH 1" MIN AND HEM UNDER CONTINUOUS CLEAT FASTEN BATT INSULATION TO METAL FLASHING -MTL STUDS AS REQUIRED BARRIER FLASHING TAPE -CONCEALED FASTENER SYSTEM -FIBER REINFORCED CEMENT PANEL -4" MIN CONT STRIP OF BARRIER FLASHING TAPE AT ALL PENETRATIONS -"Z" FURRING PUNCHED FOR DRAINAGE ——— SYNTHETIC SHEET AIR/WATER BARRIER MINERAL WOOL SEMI RIGID INSULATION —

METAL ROOFING -


FITNESS CENTER PLAN DETAIL AT FIBER CEMENT

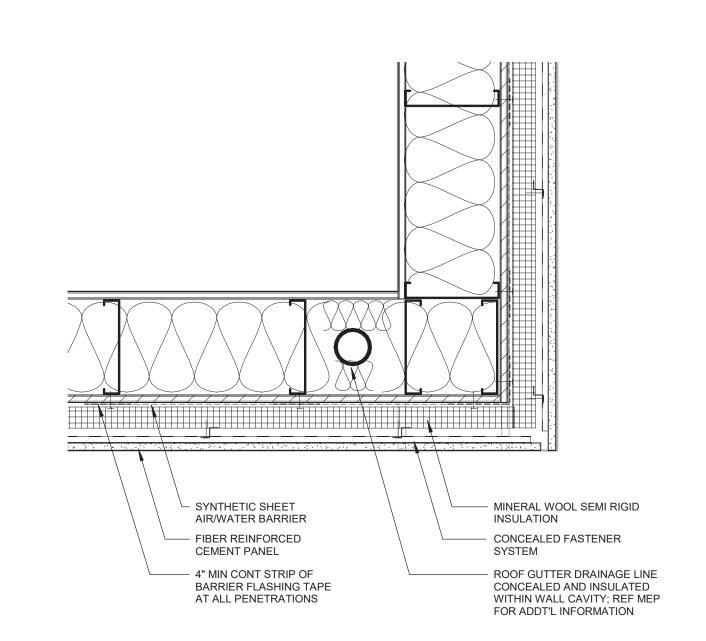

FITNESS CENTER FIBER CEMENT AND DEFS SOFFIT

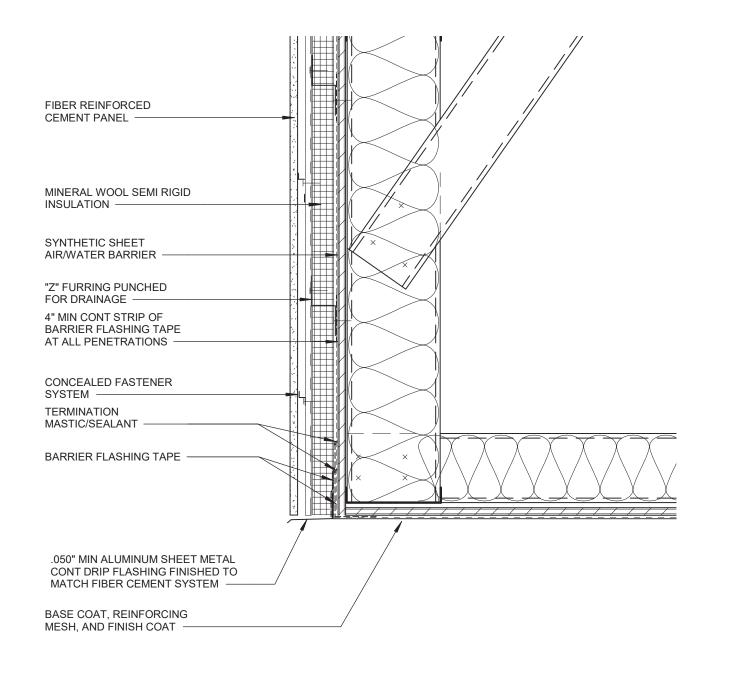

 $06^{\frac{11}{11/2"}=1"-0"}$ 

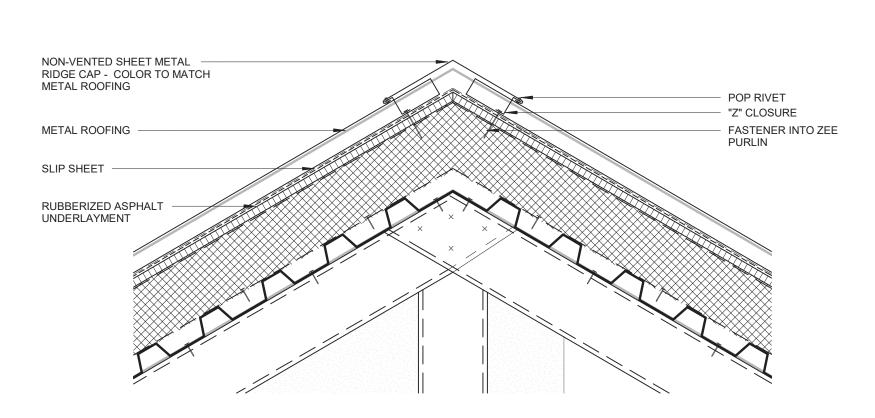

8" STEEL STUDS -SYNTHETIC SHEET AIR/WATER BARRIER 4" MIN CONT STRIP OF BARRIER FLASHING TAPE AT ALL PENETRATIONS -BARRIER FLASHING TAPE CONCEALED FASTENER SYSTEM ---.050" MIN ALUMINUM SHEET METAL CONT FLASHING FINISH TO MATCH FRC -SEALANT AND BACK ROD OVER COMPRESSIBLE JOINT REF. LANDSCAPE -\_\_\_\_\_\_ BELOW SLAB VAPOR DOWN GRADE BEAM -WATERSTOP-


 $02^{\frac{11}{12"}=1'-0"}$ 

FIBER REINFORCED


MINERAL WOOL SEMI RIGID

CEMENT PANEL -

INSULATION -

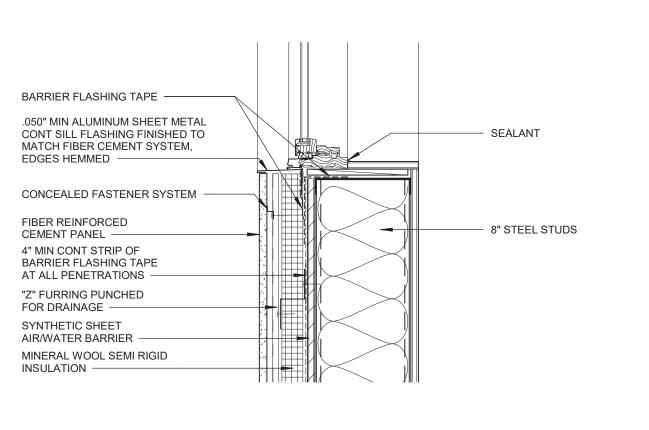

 $03^{\frac{11}{12}}$  FITNESS CENTER WINDOW HEADER SECTION DETAIL

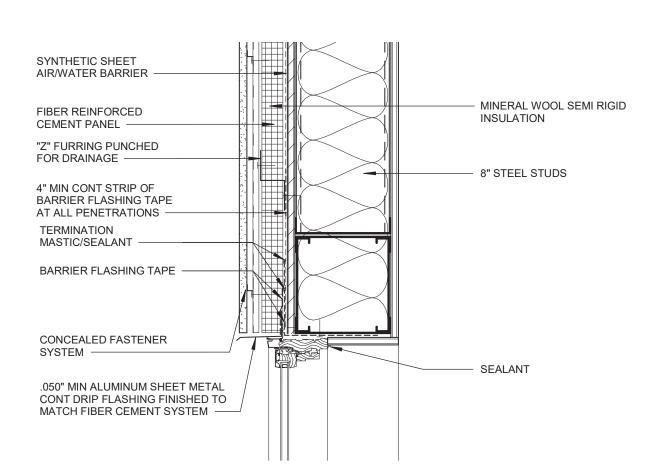

WHITE LODGING SERVICES CORPORATION

701 EAST 83RD AVE MERRILLVILLE, IN 46410 ARCHITECT

350 N SAINT PAUL ST, SUITE 100 DALLAS, TX 75201

INTERIOR DESIGNER

FLICK-MARS 10440 N. CENTRAL EXPY, NO 1210 DALLAS, TX 75231 STRUCTURAL ENGINEERS

THORNTON TOMASETTI 8750 NORTH CENTRAL EXPRESSWAY, SUITE 700 DALLAS, TX 75231

MEPF ENGINEERS

BLUM CONSULTING ENGINEERS 8144 WALNUT HILL LANE DALLAS, TX 75231 CIVIL ENGINEER

PAPE-DAWSON ENGINEERS, INC. 2000 NW LOOP 410 SAN ANTONIO, TX 78213

FOOD SERVICE EQUIPMENT NEXT STEP DESIGN 350 S. NORTHWEST HIGHWAY, SUITE 300

PARK RIDGE, IL 60068 LIGHTING CONSULTANT 3545 AINSWORTH DROVE

GRANVILLE MCANEAR LIGHTING DESIGN, LLC DALLAS, TX 75229

LANDSCAPE

TALLEY ASSOCIATES 1925 SAN JACINTO, SUITE 400

DALLAS, TX 75201

TECHNOLOGY CONSULTANT

NETWORK TECHNOLOGY, INC 320 SOUTH PERRY STREET LAWRENCEVILLE, GA 30045

VERTICAL TRANSPORTATION LERCH BATES 2001 BRYAN STREET, SUITE 1930

DALLAS TX, 75201 JENSEN HUGHES

LIFE SAFETY ENGINEER 2301 W. PLANO PARKWAY, SUITE 210 PLANO, TX 75075

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**KEY PLAN** 

REVISION


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FITNESS CENTER -DETAILS

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WHITE LODGING SERVICES CORPORATION 701 EAST 83RD AVE MERRILLVILLE, IN 46410 ARCHITECT HKS, INC.

OWNER

350 N SAINT PAUL ST, SUITE 100 DALLAS, TX 75201 INTERIOR DESIGNER

FLICK-MARS 10440 N. CENTRAL EXPY, NO 1210 DALLAS, TX 75231 STRUCTURAL ENGINEERS THORNTON TOMASETTI 8750 NORTH CENTRAL EXPRESSWAY, SUITE 700 DALLAS, TX 75231

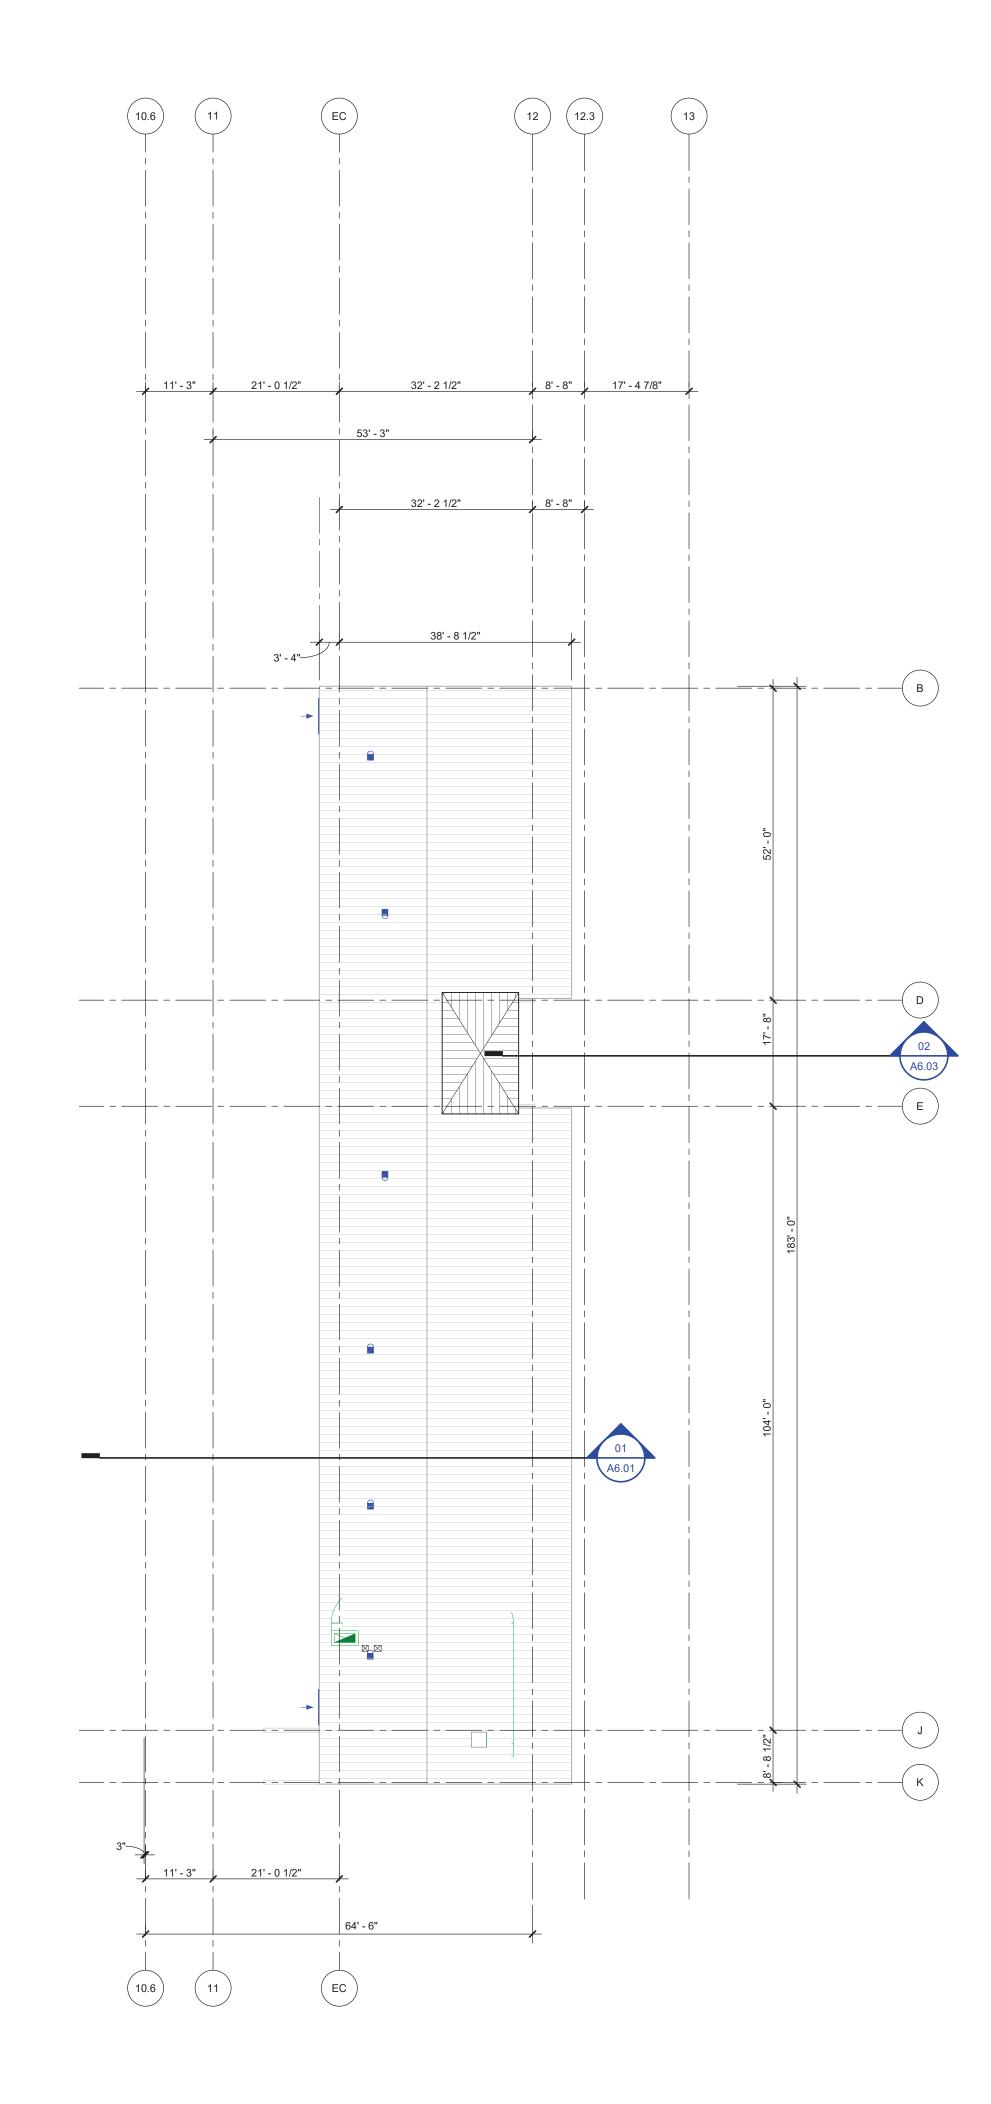MEPF ENGINEERS BLUM CONSULTING ENGINEERS 8144 WALNUT HILL LANE DALLAS, TX 75231

CIVIL ENGINEER PAPE-DAWSON ENGINEERS, INC. 2000 NW LOOP 410 SAN ANTONIO, TX 78213

FOOD SERVICE EQUIPMENT NEXT STEP DESIGN 350 S. NORTHWEST HIGHWAY, SUITE 300 PARK RIDGE, IL 60068

LIGHTING CONSULTANT GRANVILLE MCANEAR LIGHTING DESIGN, LLC 3545 AINSWORTH DROVE DALLAS, TX 75229

LANDSCAPE TALLEY ASSOCIATES 1925 SAN JACINTO, SUITE 400 DALLAS, TX 75201

TECHNOLOGY CONSULTANT NETWORK TECHNOLOGY, INC 320 SOUTH PERRY STREET LAWRENCEVILLE, GA 30045

VERTICAL TRANSPORTATION LERCH BATES 2001 BRYAN STREET, SUITE 1930 DALLAS TX, 75201

LIFE SAFETY ENGINEER JENSEN HUGHES 2301 W. PLANO PARKWAY, SUITE 210 PLANO, TX 75075

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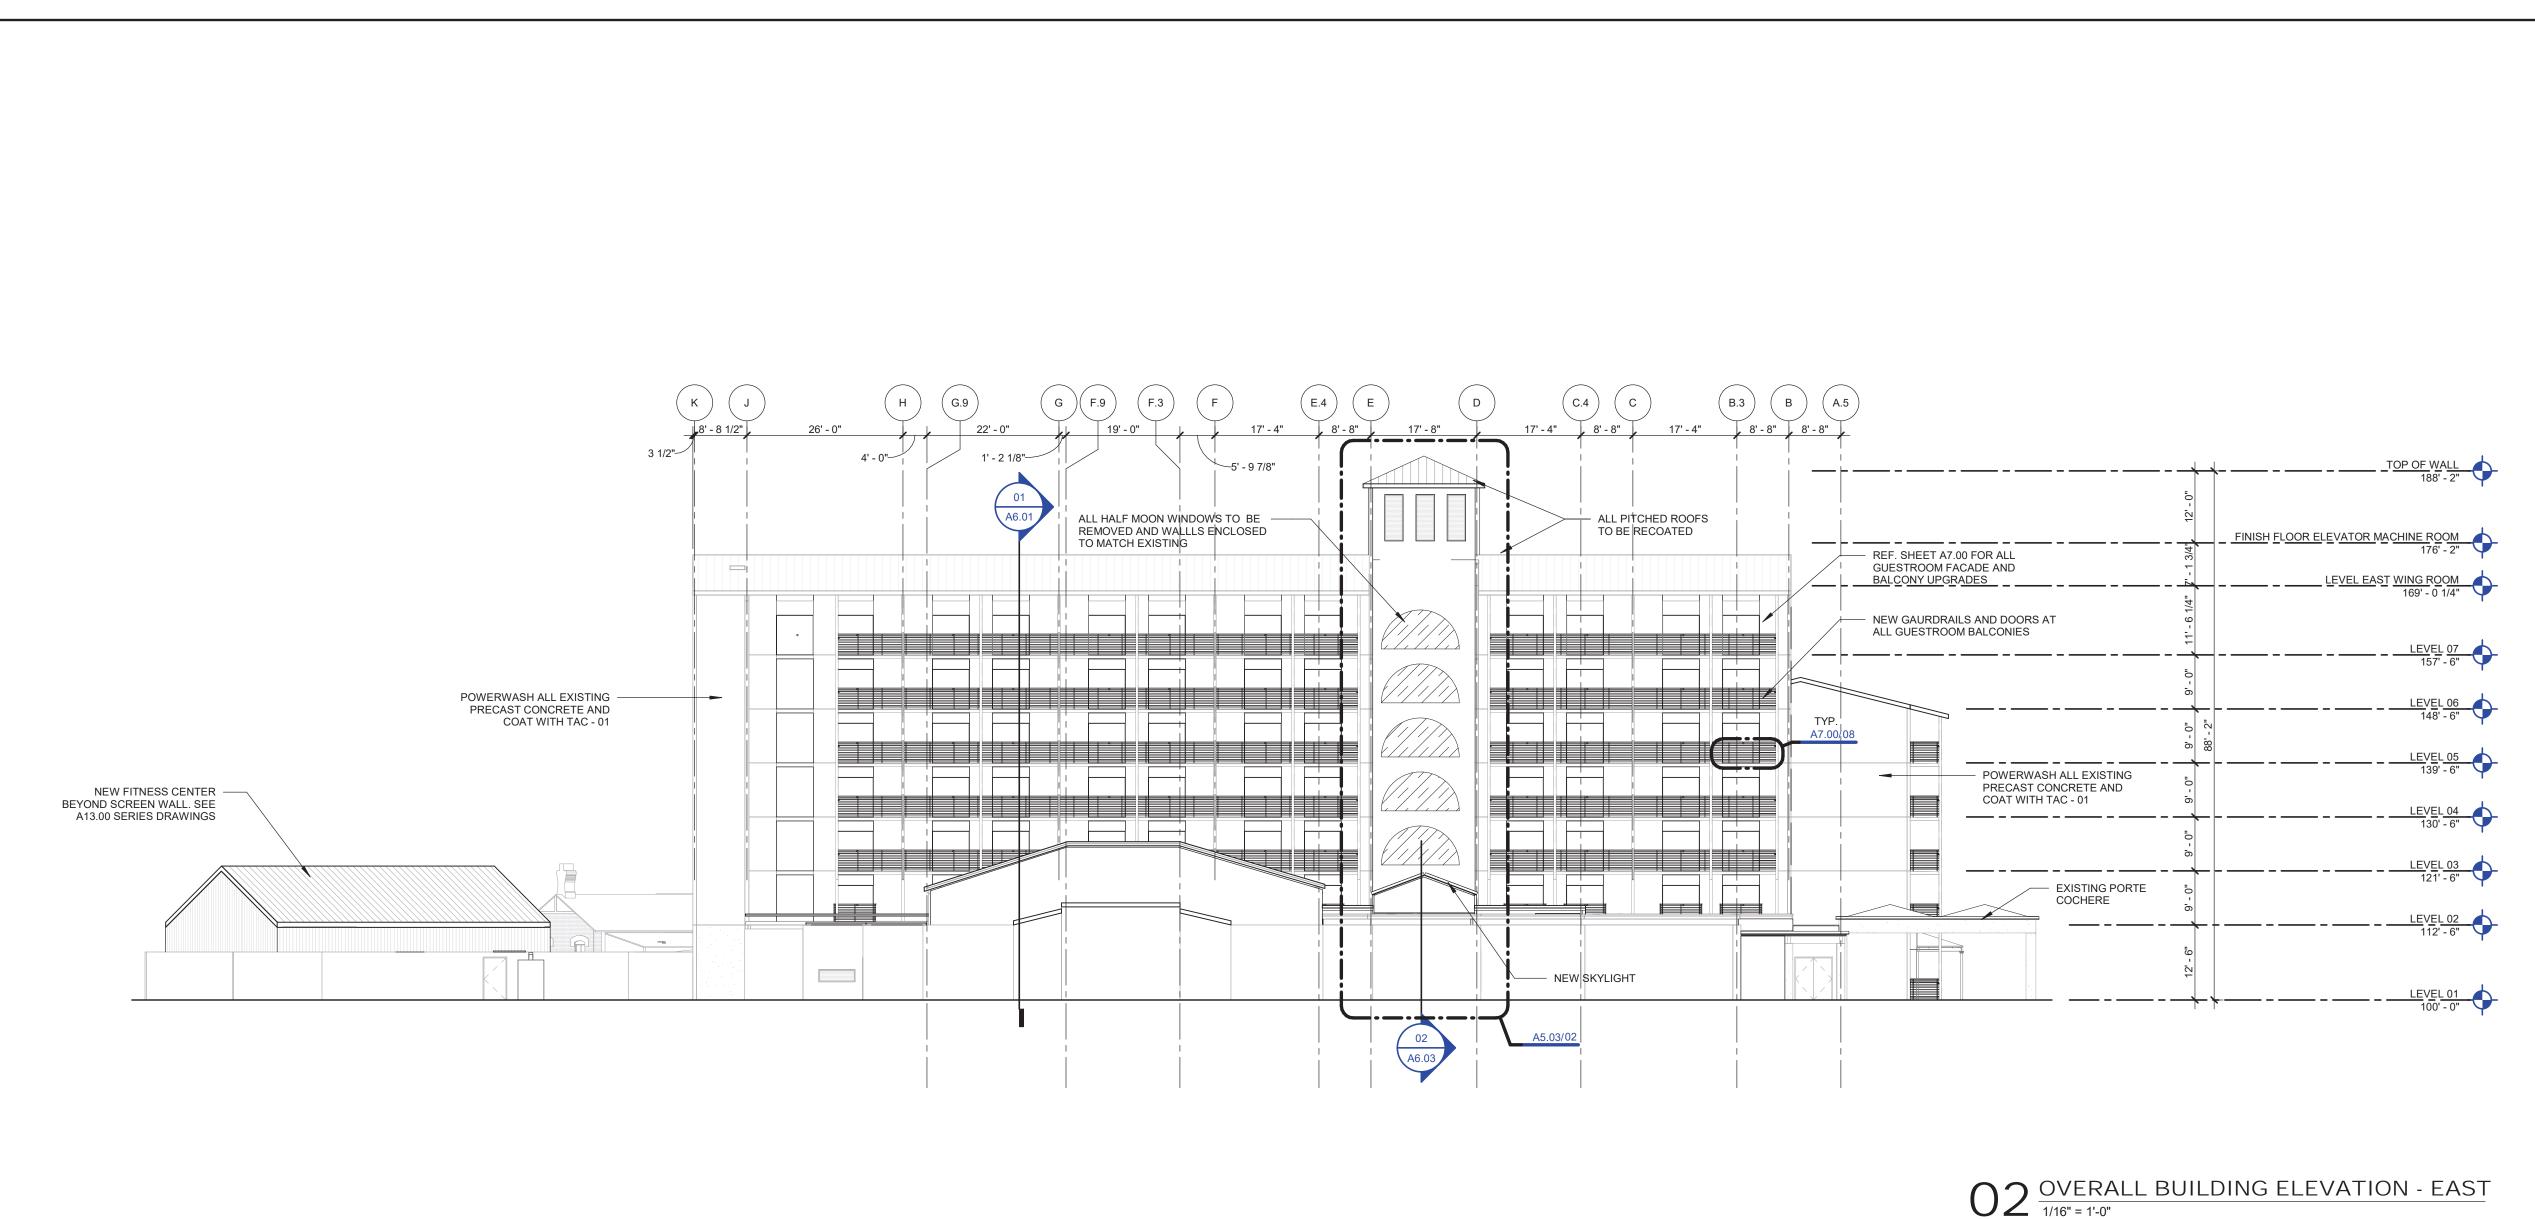
**KEY PLAN** 


REVISION NO. DESCRIPTION

HKS PROJECT NUMBER 23383.000

date 10/15/21 50% CONSTRUCTION

DOCUMENTS
SHEET TITLE
HOTEL ROOF PLAN



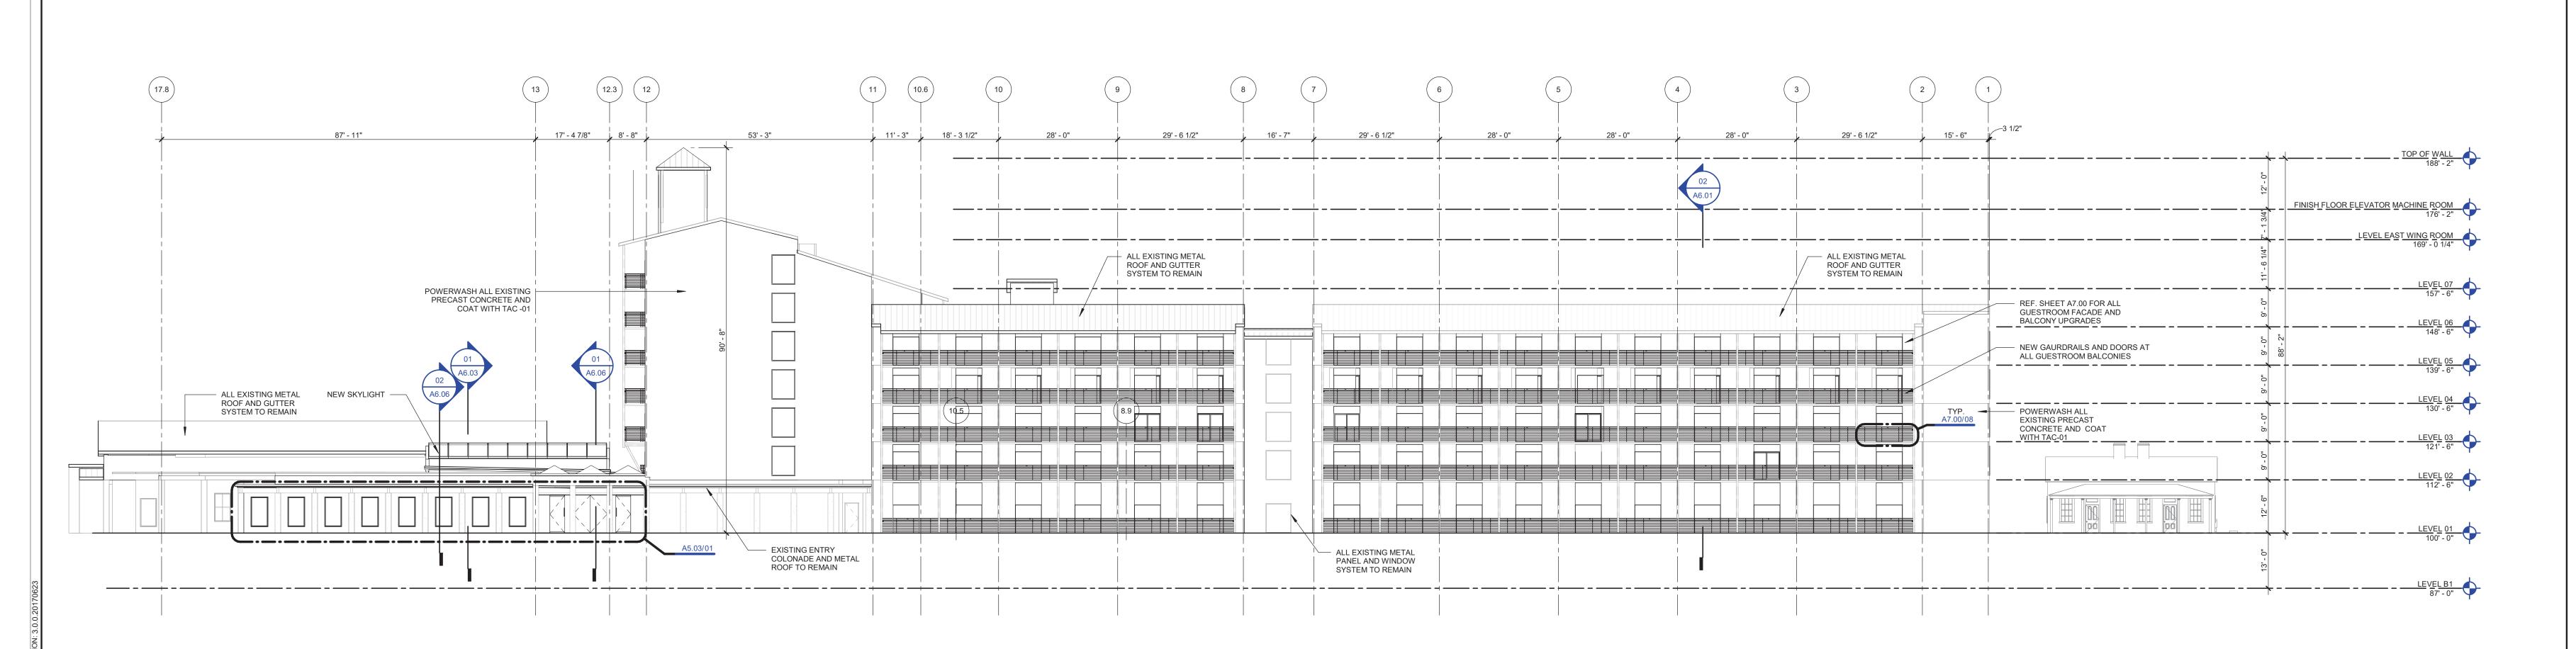

O1 OVERALL BUILDING ELEVATION - NORTH

MATERIAL LEGEND ARCHITECTURAL EXPOSED STRUCTURAL STEEL AESS-01 EXPOSED STRUCTURAL STEEL FINISH: HIGH PERFORMANCE COATING FOR STEEL COLOR: TBD ARCHITECTURAL METAL FINISH AMF-01 - GRAPHITE GRAY AMF-03 - STAINLESS STEEL **EXTERIOR INSULATING SYSTEM - EIFS** EIFS-01 EXTERIOR INSULATING FINISH SYSTEM TEXTURE: TBD DIRECT-APPLIED EXTERIOR FINISHING SYSTEM - DEFS SOFFITS **DEFS-01 EXTERIOR FINISH SYSTEM FOR SOFFITS** COLOR: TBD TEXTURE: TBD **EXTERIOR GLAZING - GL** GL-01 INSULATED COATED GLASS - VISION 1" INSULATED / LOW-E VISION GLASS BASIS OF DESIGN: VIRACON VRE 1-54 LOCATION: GUESTROOM TOWER GL-02 INSULATED COATED GLASS - VISION 1" INSULATED / LOW-E ULTRA CLEAR VISION GLASS BASIS OF DESIGN: VIRACON VE1-85 [CLEAR GLASS] LOCATION: PODIUM GL-03 INSULATED / LAMINATED / TEMPERED COATED GLASS OVERALL THICKNESS: 1-1/2" NOMINAL OUTBOARD LITE: 1/4" OUTBOARD LITE INTERLAYER: .060" CLEAR PVB OUTBOARD LITE: CLEAR HS; 1/4" THICK GLASS. AIR SPACE: 1/2"; BLACK FINISH SPACER; BLACK SEALANT. INBOARD LITE: CLEAR HS; 1/4" THICK GLASS. INBOARD CERAMIC FRIT: DARK GREY DOT FRIT 50% COVERAGE INBOARD LITE: CLEAR HS; 1/4" THICK GLASS. BASIS OF DESIGN MANUFACTURER AND PRODUCT: VIRACON VE13-2M FIBER CEMENT PANELS FRC-01 FITNESS BUILDING FACADE BASIS OF DESIGN: NICHIHA FORMAT: WALL PANEL TEXTURE: WOOD SERIES; VINTAGEWOOD FINISH COLOR: TBD **METAL PANELS** MP-01 EVENT SPACE FACADE FIELD FABRICATED STANDING SEAM METAL PANEL FINISH: AMF-02 **GLAZED ALUMINUM FRAMING SYSTEMS - GAFS** GAFS-01 PODIUM PUNCHED WINDOW SYSTEM NOTES: 6" FRAME WITH 4-SIDED CAPTURE BASIS OF DESIGN: KAWNEER 1600 WALL SYSTEM GAFS-02 FITNESS CENTER WINDOW SYSTEM BASIS OF DESIGN: PELLA - ARCHITECT SERIES; CONTEMPORARY FINISH COLOR: TBD GAFS-03 EVENT SPACE CURTAIN WALL SYSTEM NOTES: 7-1/2" FRAME WITH 4-SIDED CAPTURE BASIS OF DESIGN: KAWNEER 1600 WALL SYSTEM GAFS-04 EVENT SPACE SKYLIGHT SYSTEM BASIS OF DESIGN: KAWNEER 2000 SKYLIGHT [SSG] FINISH: TBD **ROOF TYPE - 01** FIELD FABRICATED STANDING SEAM METAL ROOF **ROOF TYPE - 02** SINGLE PLY ROOF: PVC; COLOR GRAY TRAFFIC COATING TAC-01 TRAFFIC COATING LOCATION: FACADES COLOR: TBD

TAC-02 TRAFFIC COATING

COLOR: TBD PC-01 PEDESTRIAN COATING

COLOR: TBD

WD-01 WOOD SOFFIT

WOOD - WD

LOCATION: BALCONIES

LOCATION: BALCONY SOFFITS + FASCIA

SPECIES: CLEAR GRAIN WESTERN RED CEDAR TONGUE & GROOVE 1" x 6" RANDOM LENGTHS

WHITE LODGING SERVICES CORPORATION

701 EAST 83RD AVE

ARCHITECT HKS, INC.

DALLAS, TX 75201

FLICK-MARS

DALLAS, TX 75231

DALLAS, TX 75231

DALLAS, TX 75231

2000 NW LOOP 410

NEXT STEP DESIGN

PARK RIDGE, IL 60068

3545 AINSWORTH DROVE

1925 SAN JACINTO, SUITE 400

NETWORK TECHNOLOGY, INC

2001 BRYAN STREET, SUITE 1930

LIFE SAFETY ENGINEER

2301 W. PLANO PARKWAY, SUITE 210

320 SOUTH PERRY STREET LAWRENCEVILLE, GA 30045

DALLAS, TX 75229

LANDSCAPE

DALLAS, TX 75201

LERCH BATES

DALLAS TX, 75201

JENSEN HUGHES

PLANO, TX 75075

TALLEY ASSOCIATES

THORNTON TOMASETTI

MEPF ENGINEERS

CIVIL ENGINEER

SAN ANTONIO, TX 78213

BLUM CONSULTING ENGINEERS 8144 WALNUT HILL LANE

PAPE-DAWSON ENGINEERS, INC.

FOOD SERVICE EQUIPMENT

350 S. NORTHWEST HIGHWAY, SUITE 300

GRANVILLE MCANEAR LIGHTING DESIGN, LLC

TECHNOLOGY CONSULTANT

VERTICAL TRANSPORTATION

LIGHTING CONSULTANT

MERRILLVILLE, IN 46410

350 N SAINT PAUL ST, SUITE 100

INTERIOR DESIGNER

10440 N. CENTRAL EXPY, NO 1210

STRUCTURAL ENGINEERS

8750 NORTH CENTRAL EXPRESSWAY, SUITE 700

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**KEY PLAN** 

REVISION DESCRIPTION


HKS PROJECT NUMBER 23383.000 DATE 10/15/21 50% CONSTRUCTION DOCUMENTS SHEET TITLE EXTERIOR

**ELEVATIONS-NORTH-**


SHEET NO.

A5.01

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 $0^{2}$  Overall building elevation - West

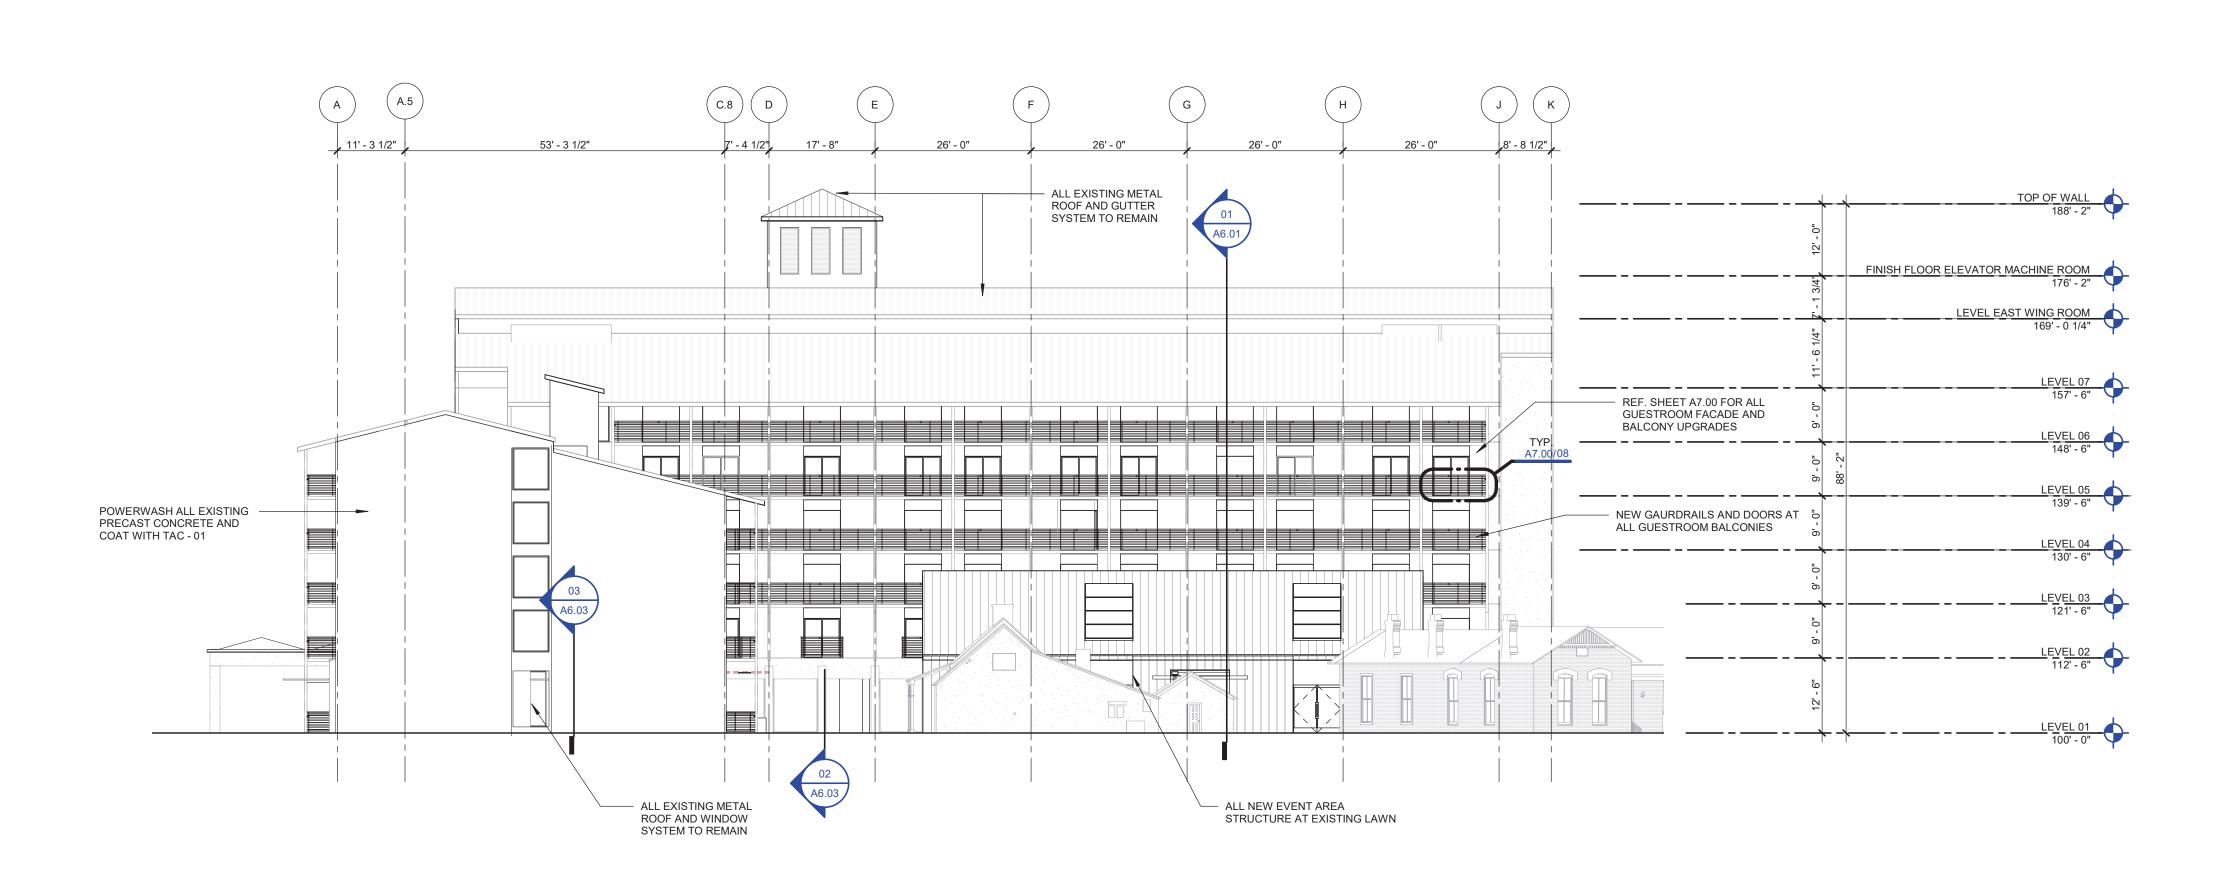

 $O_{\frac{1}{1/16"}=1'-0"}$  OVERALL BUILDING ELEVATION - SOUTH

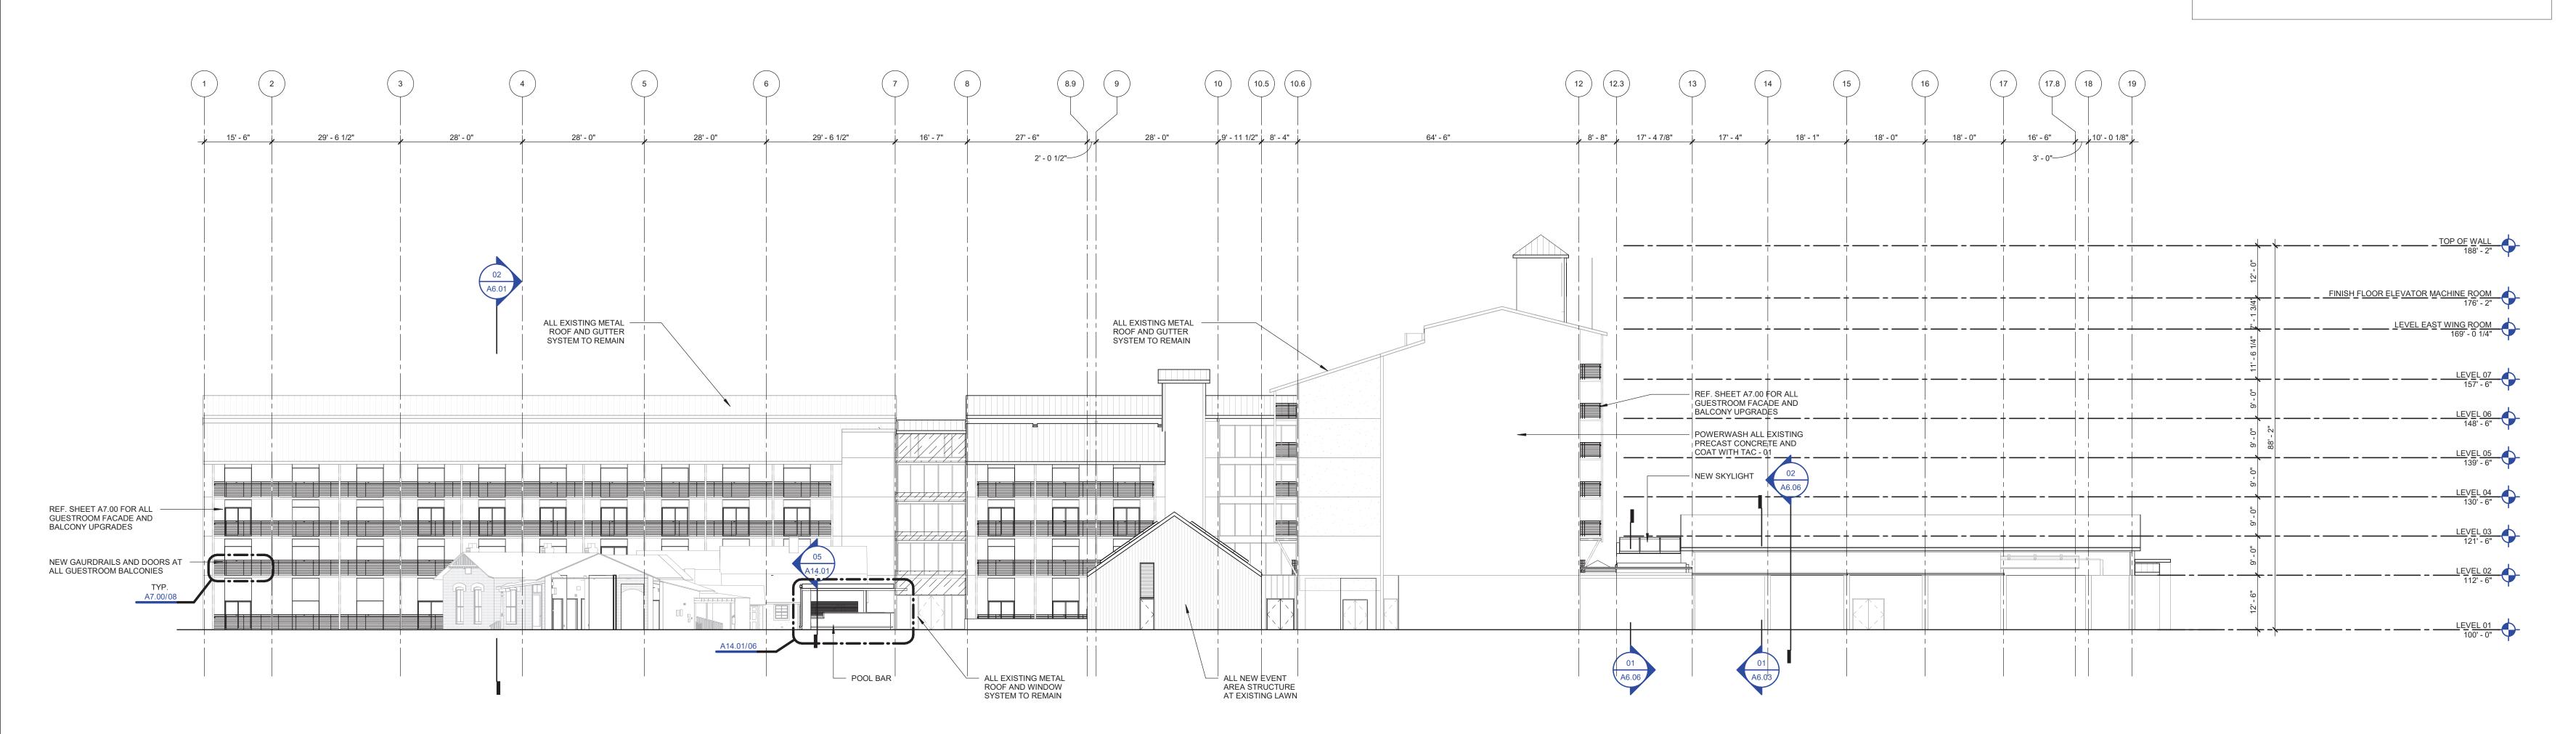MATERIAL LEGEND ARCHITECTURAL EXPOSED STRUCTURAL STEEL **AESS-01 EXPOSED STRUCTURAL STEEL** FINISH: HIGH PERFORMANCE COATING FOR STEEL COLOR: TBD ARCHITECTURAL METAL FINISH AMF-01 - GRAPHITE GRAY AMF-03 - STAINLESS STEEL **EXTERIOR INSULATING SYSTEM - EIFS** EIFS-01 EXTERIOR INSULATING FINISH SYSTEM COLOR: TBD TEXTURE: TBD DIRECT-APPLIED EXTERIOR FINISHING SYSTEM - DEFS SOFFITS DEFS-01 EXTERIOR FINISH SYSTEM FOR SOFFITS COLOR: TBD TEXTURE: TBD **EXTERIOR GLAZING - GL** GL-01 INSULATED COATED GLASS - VISION 1" INSULATED / LOW-E VISION GLASS BASIS OF DESIGN: VIRACON VRE 1-54 LOCATION: GUESTROOM TOWER GL-02 INSULATED COATED GLASS - VISION 1" INSULATED / LOW-E ULTRA CLEAR VISION GLASS BASIS OF DESIGN: VIRACON VE1-85 [CLEAR GLASS] LOCATION: PODIUM GL-03 INSULATED / LAMINATED / TEMPERED COATED GLASS OVERALL THICKNESS: 1-1/2" NOMINAL. OUTBOARD LITE: 1/4" OUTBOARD LITE INTERLAYER: .060" CLEAR PVB OUTBOARD LITE: CLEAR HS; 1/4" THICK GLASS. AIR SPACE: 1/2"; BLACK FINISH SPACER; BLACK SEALANT. INBOARD LITE: CLEAR HS; 1/4" THICK GLASS. INBOARD CERAMIC FRIT: DARK GREY DOT FRIT 50% INBOARD LITE: CLEAR HS; 1/4" THICK GLASS. BASIS OF DESIGN MANUFACTURER AND PRODUCT: VIRACON FIBER CEMENT PANELS FRC-01 FITNESS BUILDING FACADE BASIS OF DESIGN: NICHIHA FORMAT: WALL PANEL TEXTURE: WOOD SERIES; VINTAGEWOOD FINISH COLOR: TBD **METAL PANELS** MP-01 EVENT SPACE FACADE FIELD FABRICATED STANDING SEAM METAL PANEL FINISH: AMF-02 **GLAZED ALUMINUM FRAMING SYSTEMS - GAFS** GAFS-01 PODIUM PUNCHED WINDOW SYSTEM NOTES: 6" FRAME WITH 4-SIDED CAPTURE BASIS OF DESIGN: KAWNEER 1600 WALL SYSTEM FINISH: TBD GAFS-02 FITNESS CENTER WINDOW SYSTEM BASIS OF DESIGN: PELLA - ARCHITECT SERIES; CONTEMPORARY FINISH COLOR: TBD GAFS-03 EVENT SPACE CURTAIN WALL SYSTEM NOTES: 7-1/2" FRAME WITH 4-SIDED CAPTURE BASIS OF DESIGN: KAWNEER 1600 WALL SYSTEM GAFS-04 EVENT SPACE SKYLIGHT SYSTEM BASIS OF DESIGN: KAWNEER 2000 SKYLIGHT [SSG] FINISH: TBD **ROOF SYSTEMS** FIELD FABRICATED STANDING SEAM METAL ROOF FINISH: AMF-02 **ROOF TYPE - 02** SINGLE PLY ROOF: PVC; COLOR GRAY TRAFFIC COATING TAC-01 TRAFFIC COATING LOCATION: FACADES COLOR: TBD TAC-02 TRAFFIC COATING LOCATION: BALCONY SOFFITS + FASCIA COLOR: TBD PC-01 PEDESTRIAN COATING LOCATION: BALCONIES COLOR: TBD WOOD - WD WD-01 WOOD SOFFIT

SPECIES: CLEAR GRAIN WESTERN RED CEDAR TONGUE & GROOVE 1" x 6" RANDOM LENGTHS

WHITE LODGING SERVICES CORPORATION

701 EAST 83RD AVE MERRILLVILLE, IN 46410

ARCHITECT

DALLAS, TX 75201

DALLAS, TX 75231

DALLAS, TX 75231

THORNTON TOMASETTI

MEPF ENGINEERS

8144 WALNUT HILL LANE DALLAS, TX 75231

CIVIL ENGINEER

SAN ANTONIO, TX 78213

2000 NW LOOP 410

NEXT STEP DESIGN

PARK RIDGE, IL 60068

3545 AINSWORTH DROVE DALLAS, TX 75229

1925 SAN JACINTO, SUITE 400

NETWORK TECHNOLOGY, INC 320 SOUTH PERRY STREET

2001 BRYAN STREET, SUITE 1930

LIFE SAFETY ENGINEER

2301 W. PLANO PARKWAY, SUITE 210

LAWRENCEVILLE, GA 30045

LANDSCAPE TALLEY ASSOCIATES

DALLAS, TX 75201

LERCH BATES

DALLAS TX, 75201

JENSEN HUGHES

PLANO, TX 75075

BLUM CONSULTING ENGINEERS

PAPE-DAWSON ENGINEERS, INC.

FOOD SERVICE EQUIPMENT

350 S. NORTHWEST HIGHWAY, SUITE 300

GRANVILLE MCANEAR LIGHTING DESIGN, LLC

TECHNOLOGY CONSULTANT

VERTICAL TRANSPORTATION

LIGHTING CONSULTANT

FLICK-MARS

350 N SAINT PAUL ST, SUITE 100

INTERIOR DESIGNER

10440 N. CENTRAL EXPY, NO 1210

STRUCTURAL ENGINEERS

8750 NORTH CENTRAL EXPRESSWAY, SUITE 700

HKS, INC.

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**KEY PLAN** 

REVISION DESCRIPTION

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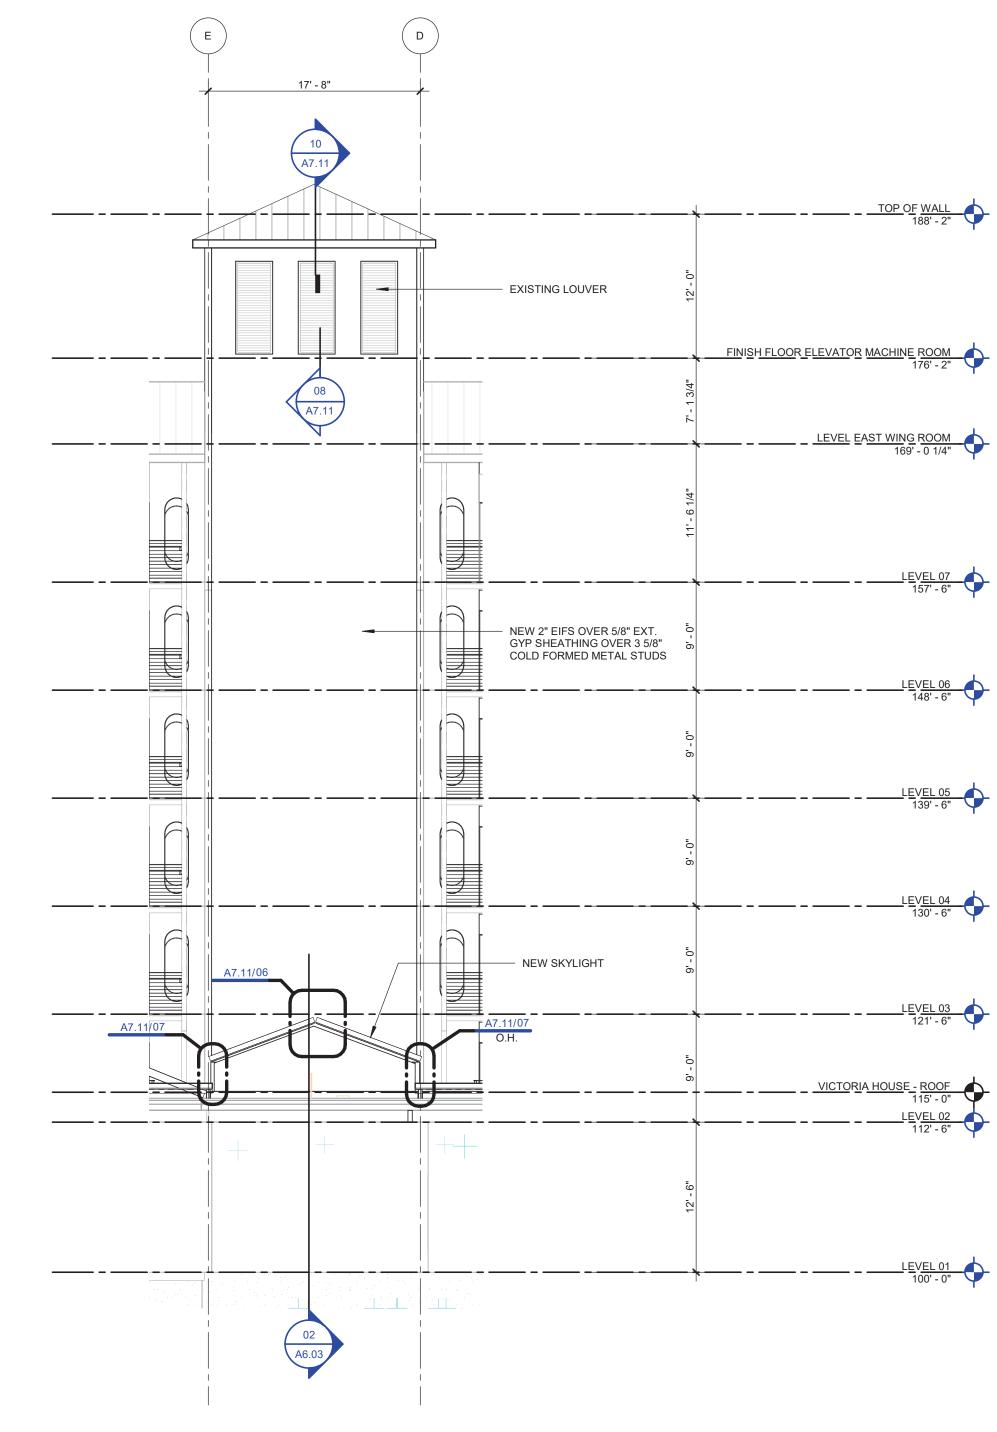
23383.000 DATE 10/15/21 50% CONSTRUCTION DOCUMENTS **EXTERIOR** 

**ELEVATIONS-SOUTH** -WEST


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 $02^{\frac{\text{ENLARGED TOWER ELEVATION}}{1/8" = 1'-0"}}$ 



**HKS** 

OWNER
WHITE LODGING SERVICES CORPORATION
701 EAST 83RD AVE
MERRILLVILLE, IN 46410

ARCHITECT

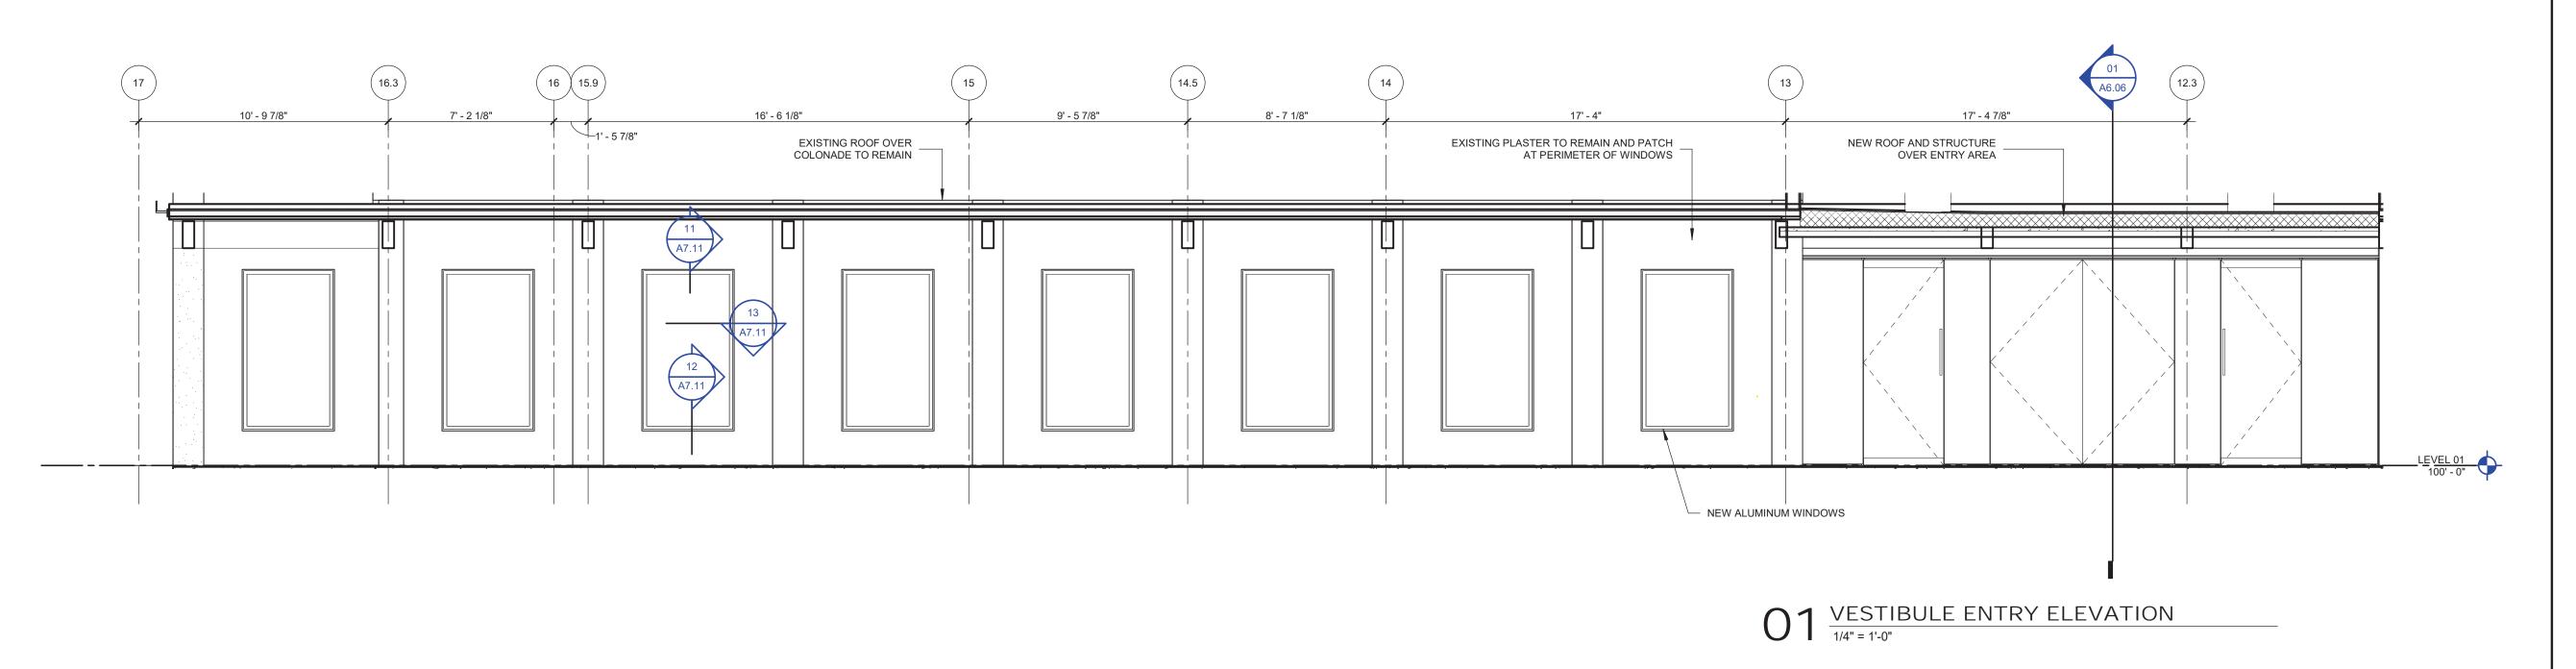HKS, INC.

100 DALLAS, TX 75201

INTERIOR DESIGNER

FLICK-MARS
10440 N. CENTRAL EXPY, NO 1210
DALLAS, TX 75231

STRUCTURAL ENGINEERS
THORNTON TOMASETTI
8750 NORTH CENTRAL EXPRESSWAY, SUITE 700

THORNTON TOMASETTI
8750 NORTH CENTRAL EXPRESSWAY, S
DALLAS, TX 75231

MEPF ENGINEERS
BLUM CONSULTING ENGINEERS

BLUM CONSULTING ENGINEERS
8144 WALNUT HILL LANE
DALLAS, TX 75231

CIVIL ENGINEER
PAPE-DAWSON ENGINEERS, INC.

2000 NW LOOP 410
SAN ANTONIO, TX 78213

FOOD SERVICE EQUIPMENT
NEXT STEP DESIGN
350 S. NORTHWEST HIGHWAY, SUITE 300

PARK RIDGE, IL 60068

LIGHTING CONSULTANT
GRANVILLE MCANEAR LIGHTING DESIGN, LLC

GRANVILLE MCANEAR LIGHTING DESIGN, LLC
3545 AINSWORTH DROVE
DALLAS, TX 75229

LANDSCAPE
TALLEY ASSOCIATES
1925 SAN JACINTO, SUITE 400
DALLAS, TX 75201

TECHNOLOGY CONSULTANT
NETWORK TECHNOLOGY, INC
320 SOUTH PERRY STREET
LAWRENCEVILLE, GA 30045

VERTICAL TRANSPORTATION

LERCH BATES
2001 BRYAN STREET, SUITE 1930
DALLAS TX, 75201

LIFE SAFETY ENGINEER

LIFE SAFETY ENGINEER
JENSEN HUGHES
2301 W. PLANO PARKWAY, SUITE 210
PLANO, TX 75075

AUCORALI COLLECTION HOTELS SAN ANTONIO, TX

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Architect: XXXXXX

Arch. Reg. No.: XXXX

Date: XX/XX/XXXX

KEY PLAN

REVISION
NO. DESCRIPTION DATE

HKS PROJECT NUMBER

23383.000

DATE

10/15/21

ISSUE


50% CONSTRUCTION

DOCUMENTS
SHEET TITLE
EXTERIOR
ELEVATIONS

SHEET NO.

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OWNER WHITE LODGING SERVICES CORPORATION 701 EAST 83RD AVE MERRILLVILLE, IN 46410 ARCHITECT

HKS, INC. 350 N SAINT PAUL ST, SUITE 100 DALLAS, TX 75201

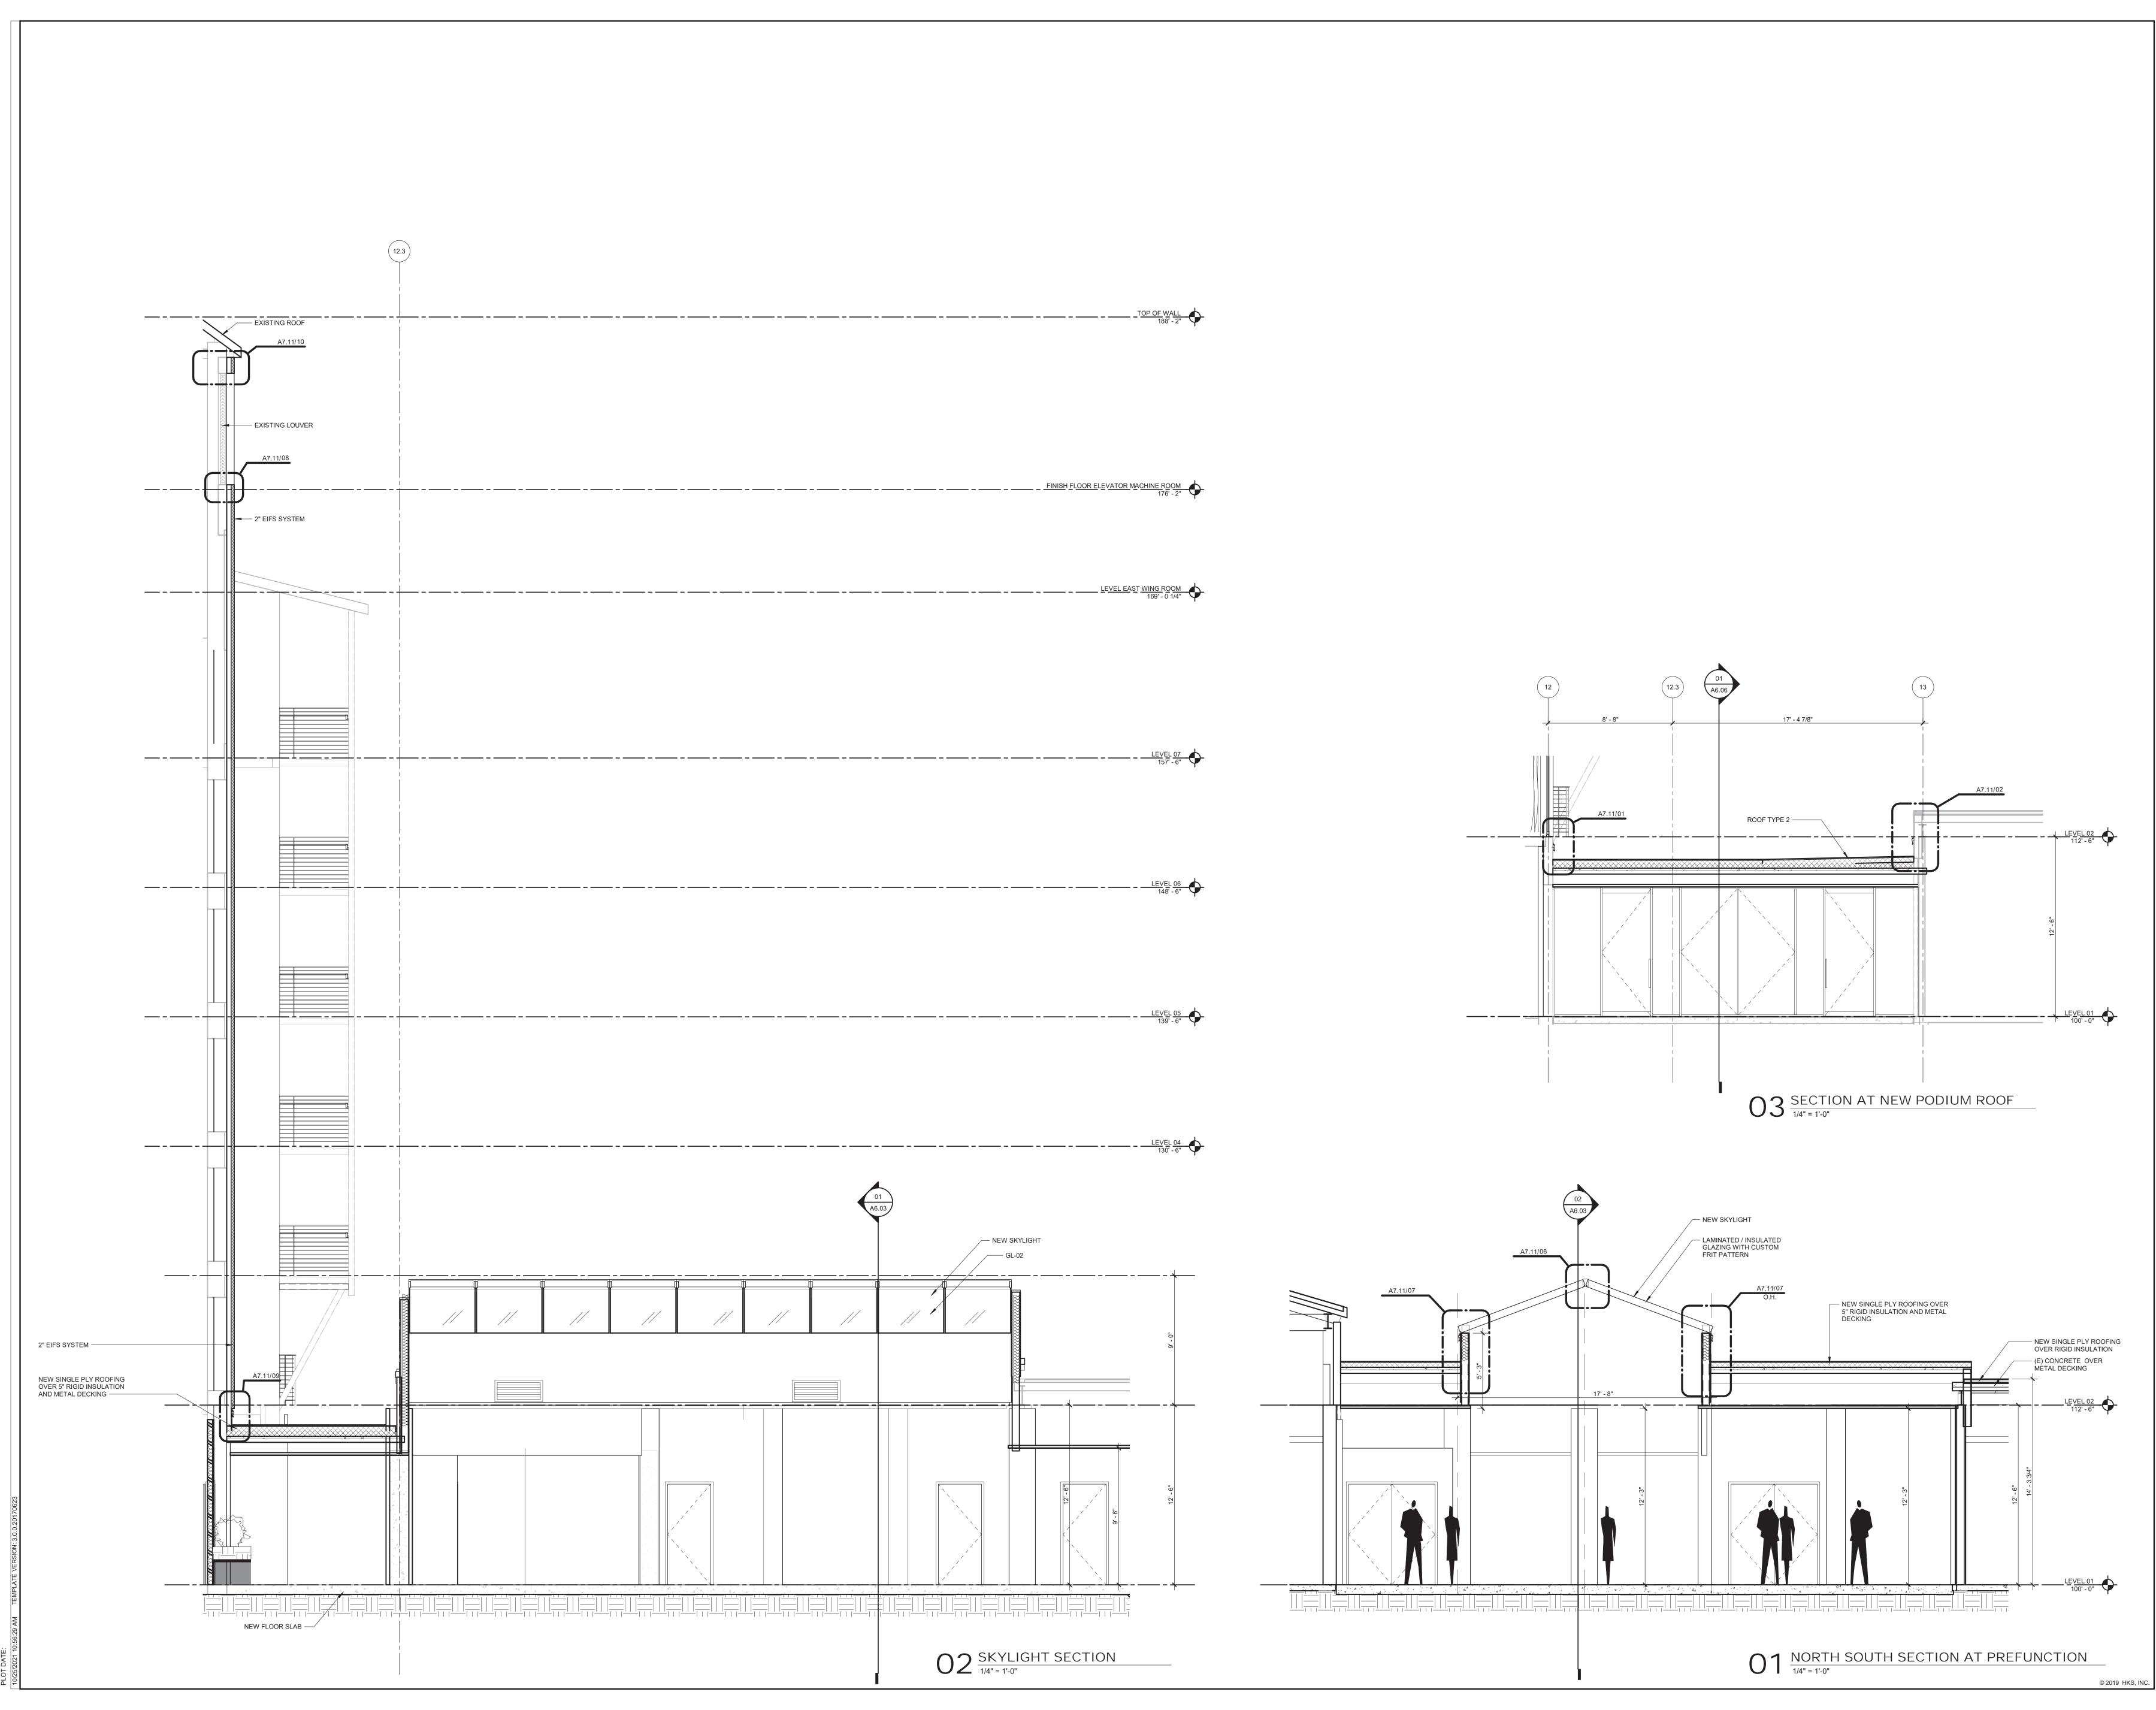INTERIOR DESIGNER FLICK-MARS 10440 N. CENTRAL EXPY, NO 1210 DALLAS, TX 75231

STRUCTURAL ENGINEERS THORNTON TOMASETTI 8750 NORTH CENTRAL EXPRESSWAY, SUITE 700 DALLAS, TX 75231

MEPF ENGINEERS BLUM CONSULTING ENGINEERS 8144 WALNUT HILL LANE DALLAS, TX 75231

CIVIL ENGINEER PAPE-DAWSON ENGINEERS, INC. 2000 NW LOOP 410 SAN ANTONIO, TX 78213 FOOD SERVICE EQUIPMENT

350 S. NORTHWEST HIGHWAY, SUITE 300 PARK RIDGE, IL 60068 LIGHTING CONSULTANT

NEXT STEP DESIGN

GRANVILLE MCANEAR LIGHTING DESIGN, LLC 3545 AINSWORTH DROVE **DALLAS, TX 75229** 

LANDSCAPE TALLEY ASSOCIATES 1925 SAN JACINTO, SUITE 400

DALLAS, TX 75201 TECHNOLOGY CONSULTANT NETWORK TECHNOLOGY, INC

320 SOUTH PERRY STREET LAWRENCEVILLE, GA 30045 VERTICAL TRANSPORTATION LERCH BATES 2001 BRYAN STREET, SUITE 1930

DALLAS TX, 75201 LIFE SAFETY ENGINEER JENSEN HUGHES

2301 W. PLANO PARKWAY, SUITE 210 PLANO, TX 75075

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**KEY PLAN** 

HKS PROJECT NUMBER 23383.000

DATE 10/15/21

50% CONSTRUCTION DOCUMENTS SHEET TITLE

PODIUM SECTIONS

SHEET NO.

A6.03

Level Roof Top 17' - 11 1/2" Level Roof Top 17' - 11 1/2" Level 2 Level 2 11' - 9 1/2" 11' - 9 1/2" STRIP EXISTING PAINT FROM EXPOSED WOOD POSTS ON BOTH PORCHES. REPLACE ROTTED WOOD WITH NEW PT WOOD IN DIMENSIONS TO MATCH EXISTING. REPAINT ALL WOOD ON THE PORCH. FACADE AND TRIM TO BE
—— REPAINTED WITH LIKE
COLORS LIGHT FIXTURES TO BE REPLACED WITH "IN-KIND" -FIXTURE \_ \_ \_ \_ \_ \_ \_ \_ \_ Floor level -3' - 1 5/8" Floor level -3' - 1 5/8"

 $04 \frac{\text{NEW\_STAFFEL HOUSE - SOUTH ELEVATION}}{1/4" = 1'-0"}$ 

 $03\frac{\text{STAFFEL HOUSE - SOUTH ELEVATION.}}{1/4" = 1'-0"}$ 

OWNER

ARCHITECT HKS, INC.

DALLAS, TX 75201

FLICK-MARS

WHITE LODGING SERVICES CORPORATION 701 EAST 83RD AVE MERRILLVILLE, IN 46410

350 N SAINT PAUL ST, SUITE 100

INTERIOR DESIGNER

10440 N. CENTRAL EXPY, NO 1210 DALLAS, TX 75231

MEPF ENGINEERS

CIVIL ENGINEER

2000 NW LOOP 410 SAN ANTONIO, TX 78213

3545 AINSWORTH DROVE DALLAS, TX 75229

LANDSCAPE TALLEY ASSOCIATES

1925 SAN JACINTO, SUITE 400 DALLAS, TX 75201

LAWRENCEVILLE, GA 30045

LERCH BATES 2001 BRYAN STREET, SUITE 1930 DALLAS TX, 75201

LIFE SAFETY ENGINEER

JENSEN HUGHES 2301 W. PLANO PARKWAY, SUITE 210 PLANO, TX 75075

BLUM CONSULTING ENGINEERS 8144 WALNUT HILL LANE DALLAS, TX 75231

PAPE-DAWSON ENGINEERS, INC.

FOOD SERVICE EQUIPMENT

NEXT STEP DESIGN 350 S. NORTHWEST HIGHWAY, SUITE 300 PARK RIDGE, IL 60068

LIGHTING CONSULTANT

GRANVILLE MCANEAR LIGHTING DESIGN, LLC

TECHNOLOGY CONSULTANT NETWORK TECHNOLOGY, INC 320 SOUTH PERRY STREET

VERTICAL TRANSPORTATION

STRUCTURAL ENGINEERS

THORNTON TOMASETTI 8750 NORTH CENTRAL EXPRESSWAY, SUITE 700 DALLAS, TX 75231

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**KEY PLAN** 

REVISION NO. DESCRIPTION DATE

HKS PROJECT NUMBER 23383.000 10/15/21

50% CONSTRCUTION DOCUMENTS

STAFFEL HOUSE -RENOVATIONS

SHEET NO.

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A12.00

BLUM CONSULTING ENGINEERS 8144 WALNUT HILL LANE DALLAS, TX 75231 PARK RIDGE, IL 60068 Level Roof Top 17' - 11 1/2" Level Roof Top 17' - 11 1/2" Level 2 Level 2 11' - 9 1/2" 11' - 9 1/2" — ALL WOOD TRIM TO BE REPAIRED AS NEEDED AND REPAINTED - ALL WOOD TRIM TO BE REPAIRED AS NEEDED AND REPAINTED - NEW SCONCE ADDED ABOVE SIGNAGE - EXISTING SIGNAGE TO BE REPLACED — ENTRY STAIRS TO BE DEMOLISHED Level 1 Floor level -3' - 1 5/8" -3' - 1 5/8"  $03^{\frac{NEW\_STAFFEL\ HOUSE\ -\ NORTH\ ELEVATION}{1/4"\ =\ 1'-0"}}$  $04\frac{\text{NEW\_STAFFEL HOUSE - EAST ELEVATION}}{\frac{1}{4"}=1'-0"}$ Level Roof Top 17' - 11 1/2" Level Roof Top 17' - 11 1/2" Level 2
11' - 9 1/2" Level 2 — ALL WOOD TRIM TO BE REPAIRED AS NEEDED AND REPAINTED — ALL WOOD TRIM TO BE REPAIRED AS NEEDED AND REPAINTED EXISTING LIGHT FIXTURES TO BE REPLACED "IN-KIND" — EXTERIOR DOOR TO BE PERMANENTLY SHUT REVISION Level 1 Floor level -3' - 1 5/8" Floor level -3' - 1 5/8"  $02^{\frac{NEW\_STAFFEL}{1/4"}}$  HOUSE - WEST ELEVATION  $O_{1/4"=1'-0"}$  NEW\_STAFFEL HOUSE - SOUTH ELEVATION SHEET NO. © 2019 HKS, INC.

OWNER WHITE LODGING SERVICES CORPORATION 701 EAST 83RD AVE MERRILLVILLE, IN 46410

ARCHITECT HKS, INC.

350 N SAINT PAUL ST, SUITE 100 DALLAS, TX 75201 INTERIOR DESIGNER FLICK-MARS

10440 N. CENTRAL EXPY, NO 1210 DALLAS, TX 75231 STRUCTURAL ENGINEERS THORNTON TOMASETTI 8750 NORTH CENTRAL EXPRESSWAY, SUITE 700

DALLAS, TX 75231 MEPF ENGINEERS

CIVIL ENGINEER PAPE-DAWSON ENGINEERS, INC. 2000 NW LOOP 410 SAN ANTONIO, TX 78213

FOOD SERVICE EQUIPMENT NEXT STEP DESIGN 350 S. NORTHWEST HIGHWAY, SUITE 300

LIGHTING CONSULTANT GRANVILLE MCANEAR LIGHTING DESIGN, LLC

3545 AINSWORTH DROVE DALLAS, TX 75229

LANDSCAPE TALLEY ASSOCIATES 1925 SAN JACINTO, SUITE 400

DALLAS, TX 75201 TECHNOLOGY CONSULTANT NETWORK TECHNOLOGY, INC

320 SOUTH PERRY STREET LAWRENCEVILLE, GA 30045 VERTICAL TRANSPORTATION

LERCH BATES 2001 BRYAN STREET, SUITE 1930 DALLAS TX, 75201

LIFE SAFETY ENGINEER JENSEN HUGHES 2301 W. PLANO PARKWAY, SUITE 210 PLANO, TX 75075

INTERIM REVIEW ONLY These documents are incomplete, and are released for interim review only and are not intended for regulatory approval, permit, or construction purposes. Architect: XXXXXX

Arch. Reg. No.: XXXX Date: XX/XX/XXXX

**KEY PLAN** 

HKS PROJECT NUMBER 23383.000

10/15/21 50% CONSTRCUTION DOCUMENTS STAFFEL HOUSE -

NEW ELEVATIONS

A12.06

- Level Roof Top 20' - 7 1/4" Level Roof Top 20' - 7 1/4" Level 2 12' - 9 1/2" Level 2
12' - 9 1/2" REPAINT ALL PLASTER AND WOOD

TRIM ON HOUSE WITH LIKE REPAINT ALL PLASTER AND WOOD TRIM ON HOUSE STRIP EXISTING PAINT FROM
EXPOSED WOOD POSTS ON BOTH
PORCHES. REPLACE ROTTED
— WOOD WITH NEW PT WOOD IN
DIMENSIONS TO MATCH EXISTING.
REPAINT ALL WOOD ON THE LIGHT FIXTURES TO BE REPLACED WITH "IN-KIND" — FIXTURE NEW SIGNAGE PLAQUE — NEW ENTRY DOOR WITH "IN-KIND"
STILES, GLAZING, AND PANELING
TO MEET ACCESSIBILITY
REQUIREMENTS
Level 1
1' - 3 3/4" EXISTING DOOR TO BE PERMANENTLY SHUT Level 1 1' - 3 3/4" Lover level -1' - 2 1/8" -\frac{\text{Lover level}}{-1' - 2 1/8"}  $04 \frac{\text{NEW - TYLOR HOUSE - NORTH ELEVATION.}}{1/4" = 1'-0"}$ 

 $03\frac{\text{EXISTING - TYLOR HOUSE - NORTH ELEVATION.}}{1/4" = 1'-0"}$ 

AUTOGRAPH COLLECTION® HOTELS SAN ANTONIO, TX

OWNER

ARCHITECT HKS, INC.

DALLAS, TX 75201

WHITE LODGING SERVICES CORPORATION 701 EAST 83RD AVE MERRILLVILLE, IN 46410

350 N SAINT PAUL ST, SUITE 100

INTERIOR DESIGNER

FLICK-MARS 10440 N. CENTRAL EXPY, NO 1210 DALLAS, TX 75231

MEPF ENGINEERS

CIVIL ENGINEER

2000 NW LOOP 410 SAN ANTONIO, TX 78213

3545 AINSWORTH DROVE DALLAS, TX 75229

LANDSCAPE TALLEY ASSOCIATES

1925 SAN JACINTO, SUITE 400 DALLAS, TX 75201

LAWRENCEVILLE, GA 30045

DALLAS TX, 75201

LERCH BATES 2001 BRYAN STREET, SUITE 1930

LIFE SAFETY ENGINEER

JENSEN HUGHES 2301 W. PLANO PARKWAY, SUITE 210 PLANO, TX 75075

BLUM CONSULTING ENGINEERS 8144 WALNUT HILL LANE DALLAS, TX 75231

PAPE-DAWSON ENGINEERS, INC.

FOOD SERVICE EQUIPMENT

NEXT STEP DESIGN 350 S. NORTHWEST HIGHWAY, SUITE 300 PARK RIDGE, IL 60068

LIGHTING CONSULTANT

GRANVILLE MCANEAR LIGHTING DESIGN, LLC

TECHNOLOGY CONSULTANT NETWORK TECHNOLOGY, INC 320 SOUTH PERRY STREET

VERTICAL TRANSPORTATION

STRUCTURAL ENGINEERS

THORNTON TOMASETTI 8750 NORTH CENTRAL EXPRESSWAY, SUITE 700 DALLAS, TX 75231

INTERIM REVIEW ONLY

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Architect: XXXXXX

Arch. Reg. No.: XXXX

Date: XX/XX/XXXX

KEY PLAN

REVISION

NO. DESCRIPTION DATE

HKS PROJECT NUMBER
23383.000
DATE

23383.000


DATE
10/15/21
ISSUE
50% CONSTRCUTION
DOCUMENTS


ELEMENDORF TYLER HOUSE RENOVATIONS

SHEET NO.

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A11.00



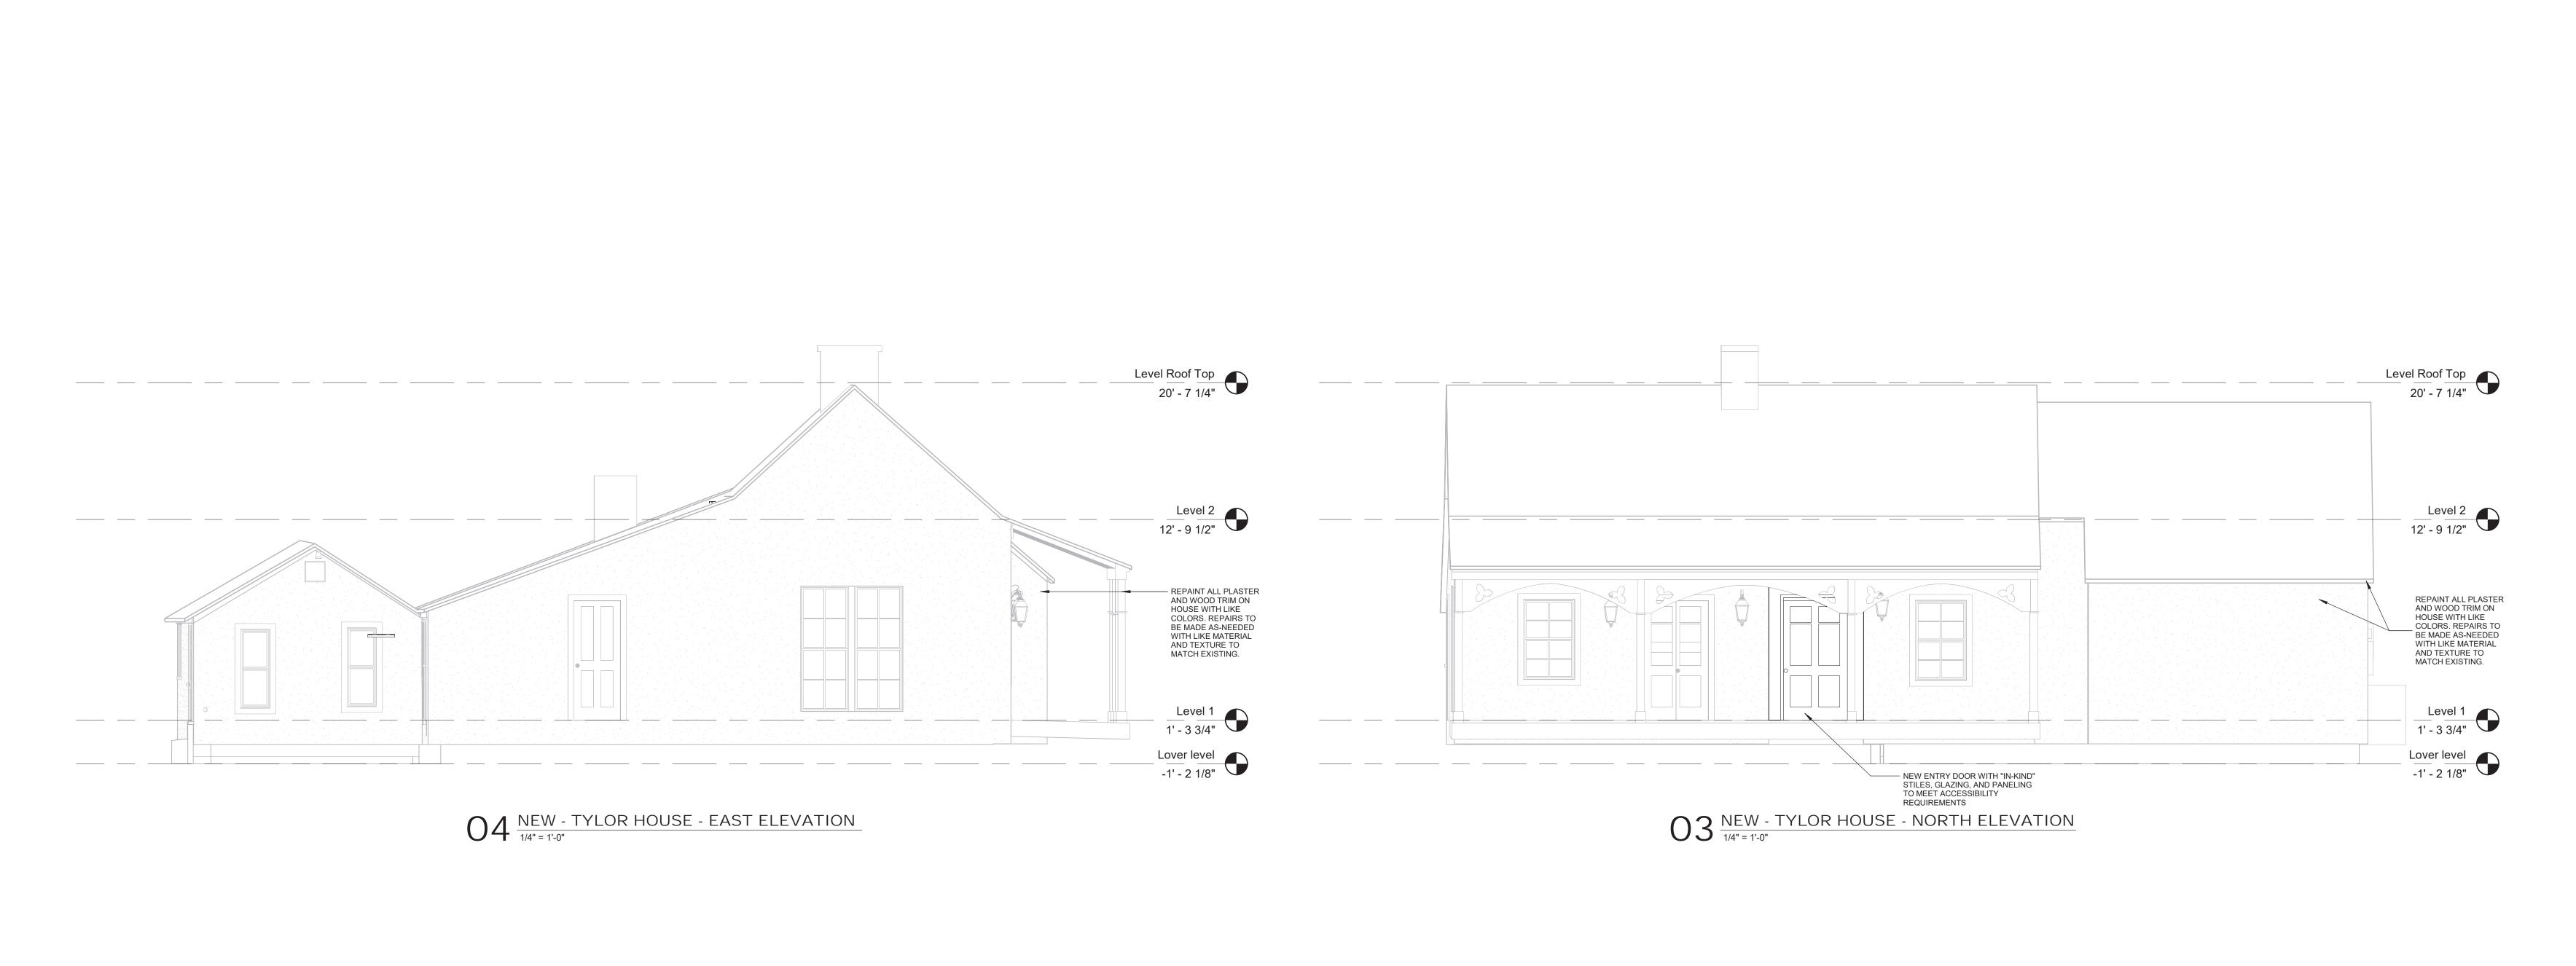

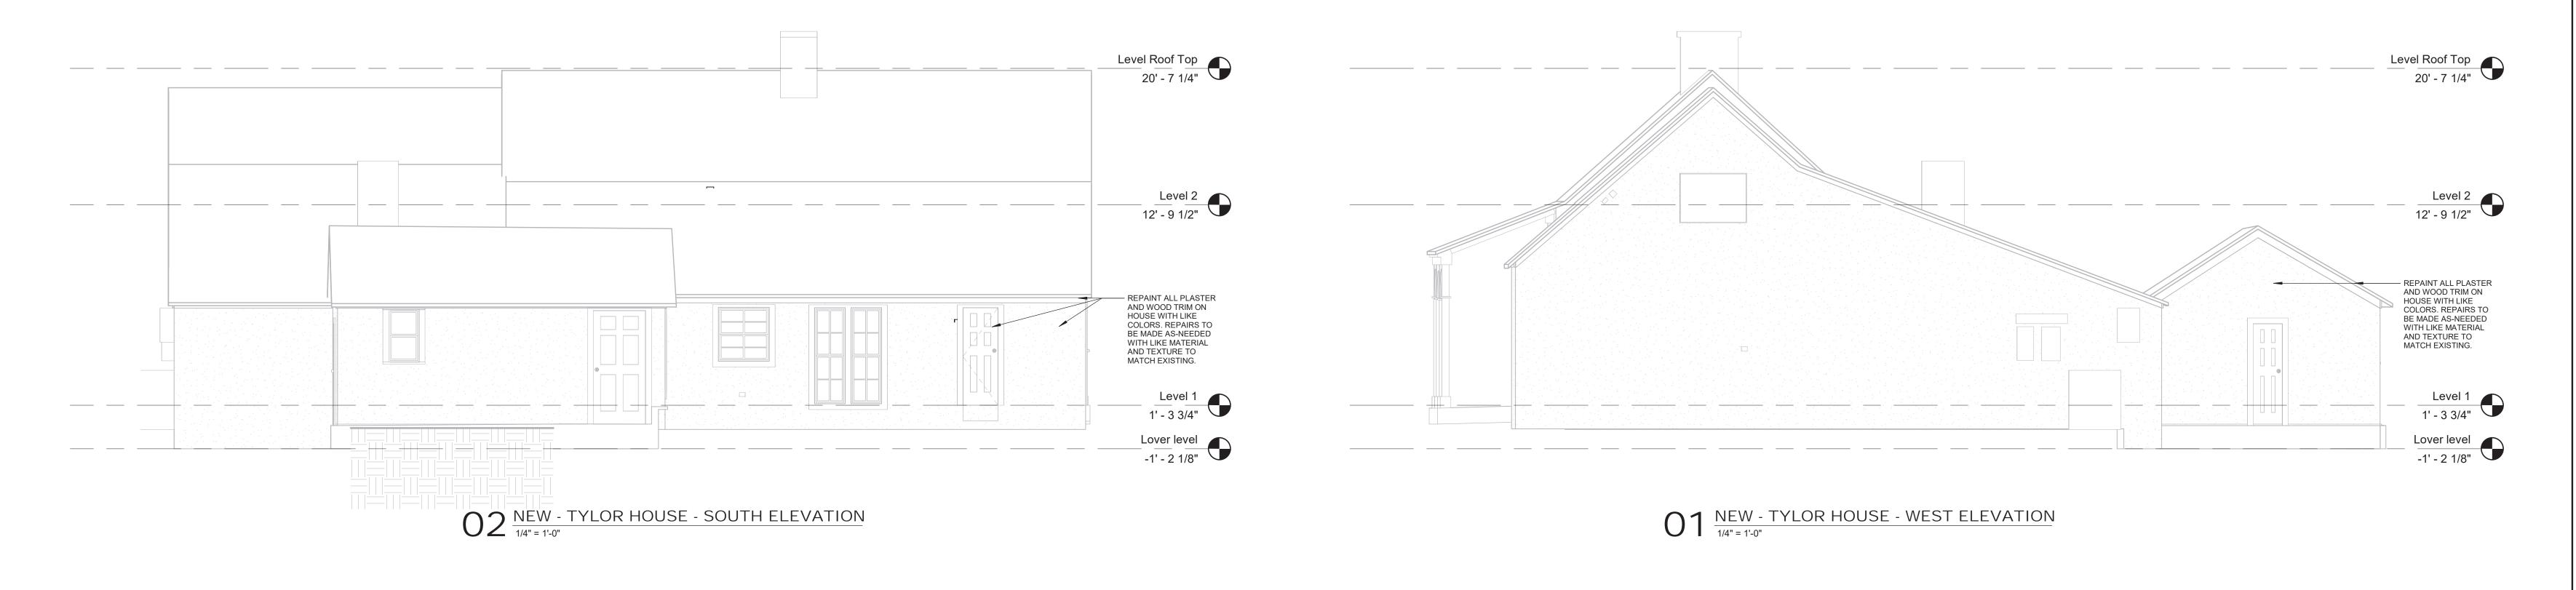OWNER WHITE LODGING SERVICES CORPORATION 701 EAST 83RD AVE MERRILLVILLE, IN 46410 ARCHITECT HKS, INC. 350 N SAINT PAUL ST, SUITE 100

DALLAS, TX 75201 INTERIOR DESIGNER FLICK-MARS 10440 N. CENTRAL EXPY, NO 1210

DALLAS, TX 75231 STRUCTURAL ENGINEERS THORNTON TOMASETTI 8750 NORTH CENTRAL EXPRESSWAY, SUITE 700 DALLAS, TX 75231

BLUM CONSULTING ENGINEERS 8144 WALNUT HILL LANE DALLAS, TX 75231 CIVIL ENGINEER PAPE-DAWSON ENGINEERS, INC.

MEPF ENGINEERS

2000 NW LOOP 410 SAN ANTONIO, TX 78213 FOOD SERVICE EQUIPMENT NEXT STEP DESIGN 350 S. NORTHWEST HIGHWAY, SUITE 300

PARK RIDGE, IL 60068 LIGHTING CONSULTANT GRANVILLE MCANEAR LIGHTING DESIGN, LLC

3545 AINSWORTH DROVE DALLAS, TX 75229

LANDSCAPE TALLEY ASSOCIATES 1925 SAN JACINTO, SUITE 400 DALLAS, TX 75201

TECHNOLOGY CONSULTANT NETWORK TECHNOLOGY, INC 320 SOUTH PERRY STREET LAWRENCEVILLE, GA 30045

VERTICAL TRANSPORTATION LERCH BATES 2001 BRYAN STREET, SUITE 1930 DALLAS TX, 75201

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INTERIM REVIEW ONLY These documents are incomplete, and are released for interim review only and are not intended for regulatory approval, permit, or construction purposes. Architect: XXXXXX Arch. Reg. No.: XXXX Date: XX/XX/XXXX

**KEY PLAN** 

REVISION

HKS PROJECT NUMBER 23383.000

10/15/21 50% CONSTRCUTION DOCUMENTS SHEET TITLE ELEMENDORF -TYLER HOUSE - NEW

ELEVATIONS

SHEET NO.

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A11.06

SAN ANTONIO HOTEL

SIGNAGE PROPOSAL

19 OCTOBER 2021

#### Historic District Signage Guidelines

#### 1. General:

- a. Each building is allowed 1 major sign and 2 minor signs.
- b. The total of requested signage should not exceed **50 square feet.**
- c. Signs should be designed to respect and respond to the character and period of the area they are placed.
- d. Signs should not create visual clutter.
- e. Signs should be in proportion to the façade they are placed respecting the buildings size, scale, mass and height.
- f. Appropriate materials should be used.
- g. Colors on signs is limited to 3 colors.
- h. Letter styles and sizes should complement the overall character of the building façade.
- i. **Internal illumination of signs is not to be used**....Reverse channel letters may be permitted.
- 2. Awning and Canopy Signs:
- a. Signs are to be placed on the awning or canopy valance.
- b. Internal illumination is prohibited
- 3. Projecting and Wall Mounted Signs
- a. Projecting Signs are to be perpendicular to the building or column and 8 feet of overhead clearance above public walkways.
- b. Limit the extension of projecting signs to the building façade into the public right of way for maximum distance of eight feet or a distance equal to two-thirds the width of abutting sidewalk, whichever distance is greater.
- c. Wall mounted signs are limited to 25 percent of the building façade.
- d. Wall mounted signs should not project more than twelve inches from the building wall.
- e. Internally illuminated wall mounted channel letters for new signs are not allowed unless there is existing historic precedent...reverse channel letters may be permitted.

### LA VILLITA HISTORIC DISTRICT

## SIGNAGE GUIDELINES

#### 4. Freestanding Signs:

- a. Freestanding signs should be placed near the public right of way where they are clearly visible to pasting pedestrians and motorists, a minimum of 5 feet from the street right of way and 10 feet from all interior side lot lines.
- b. The use of freestanding signs is limited to 1 unless the lot fronts more than one street, in which case, there is 1 sign allowed on each street the lot has frontage.
- c. Freestanding signs are limited to 6 ft and should not exceed 25 square feet on either side.

#### 5. Window Signs:

- a. Are to be limited to the first floor windows.
- b. Window signs should not cover more than 30 percent of the window area and should not be constructed of opaque material that would obstruct views into and out of windows.
- c. Paper signs are not to be used.


### It may be possible the owner could qualify for a Development Agreement (Sign Master Plan) if:

- a. There are 2 or more contiguous lots
- b. All owners must agree in writing that neither they nor their successors in ownership shall exceed the maximum height, square footage and number on any of the lots within the plan.
- c. All existing signs within the Master Sign Plan Agreement must be in conformance with Chapter 10.







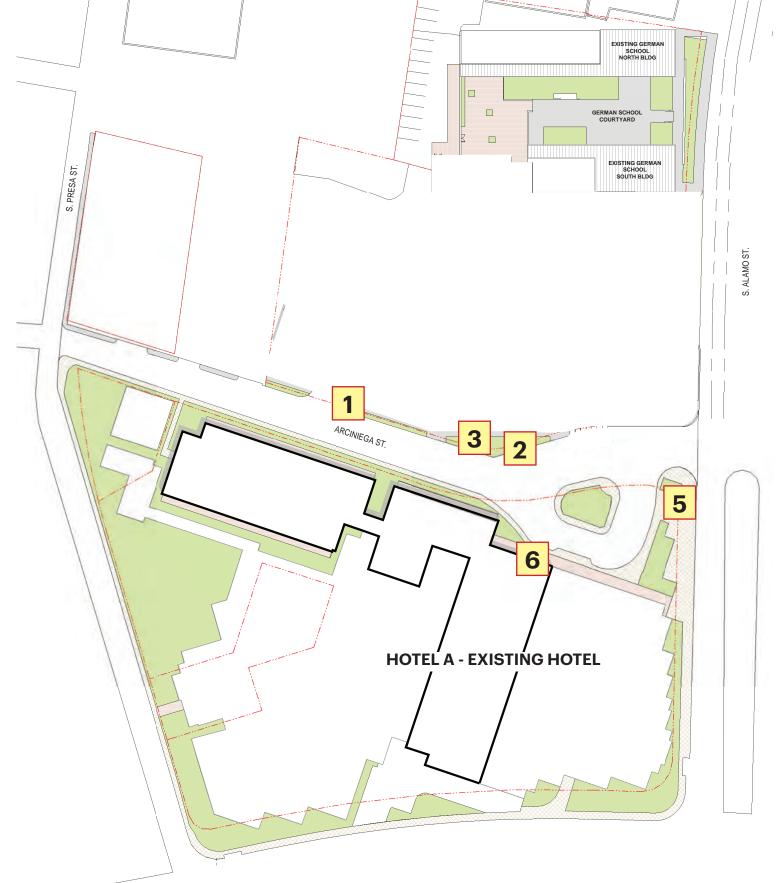

# EXISTING SIGNAGE LOCATION MAP





# SIGNAGE

## **MATRIX**

### SAN ANTONIO HOTEL

#### PROPOSED SIGN MATRIX

	ТҮРЕ	LOCATION	AREA	QTY.	ELEVATION	NOTES
<b>HOTEL A - EXISTII</b>	NG HOTEL					
		C.CHAVEZ ST + S. ALAMO				
A-1	MONUMENT, INGROUND LIGHTING	ST	100 SF	1	GROUND LVL	HOTEL A INTERSECTION MONUMENT SIGN
		C.CHAVEZ ST + S. ALAMO				REPLACEMENT OF EXISTING MARRIOTT EVENT HIGH
A-2.1 + A-2.2	HIGH BLDG SIGN, HALO LIGHTING	ST	150 SF	2	LVL 6	SIGN AT ONE LOCATION
						REFURBISHMENT OF EXISTING MARRIOTT MONUMENT
A-3	MONUMENT, INGROUND LIGHTING	S. ALAMO ST	176 SF	1	GROUND LVL	SIGN AT HOTEL A ENTRY; DUALSIDED
						HOTEL A . D MONUMENT SECONDARY (FESTIVAL DAY)
C-1	MONUMENT. INGROUND LIGHTING	S. PRESA ST.	100 SF	1	GROUND LVL	HOTEL A + B MONUMENT SECONDARY [FESTIVAL DAY] SIGN AT S. PRESA ST.
C-1	MONOMENT, INGROOMS EIGHTING	3. FRESA 31.	100.35	1	GROUND LVL	HOTEL A + B MONUMENT SECONDARY [FESTIVAL DAY]
C-2	MONUMENT, INGROUND LIGHTING	ARCINIEGA ST.	50 SF	1	GROUND LVL	SIGN AT MOTOR COURT

### **EXISTING SIGN MATRIX**

		ТҮРЕ	LOCATION	AREA	QTY.	ELEVATION	NOTES
SIGNS				[ALL APPROX.]			
	1	MONUMENT SIGN	ARCINIEGA ST.	18 SF	1	GROUND LVL	DUALSIDED; TO BE REPLACED BY NEW SIGN B-7
	2	MONUMENT SIGN	ARCINIEGA ST.	18 SF	1	GROUND LVL	DUALSIDED; TO BE REPLACED BY NEW SIGN C-2
	3	BANNER SIGN	ARCINIEGA ST.	14 SF	1	GROUND LVL	TO BE REPLACED BY SIGN B-6
	5	MONUMENT SIGN, INGROUND LIGHTING	S. ALAMO ST.	176 SF	1	GROUND LVL	DUALSIDED; TO BE RENOVATED/REPLACED BY SIGN A-3
	6	HIGH SIGN, INTERNALLY LIT	ARCINIEGA ST.	100 SF	1	LVL 6	TO BE RENOVATED/REPLACED BY SIGN A-2.2

TOTAL PROPOSED SIGNAGE	726 SF
TOTAL EXISTING SIGNAGE	326 SF



C. CHAVEZ + S. ALAMO STREETS





VIEW AT

# S. ALAMO STREET + ARCINIEGA STREET

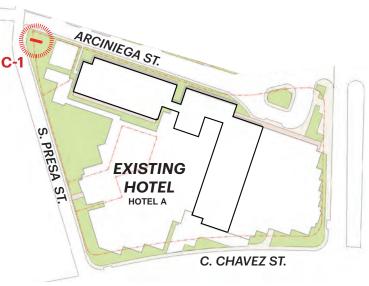


IMAGE OF EXISTING HIGH SIGN AND MONUMENT SIGN





ARCINIEGA STREET + S. PRESA STREET





# VIEW AT ARCINIEGA STREET

